

R/S REINFORCING STEEL

W.G. WIRED GLASS W.H. WATER HEATER

W.HYD. WALL HYDRANT

WATERPROOF

W.W.F. WELDED WIRE FABRIC

WINDW WINDOW

W/O WITHOUT
WP WATERPRO

YD YARD

WSCT WAINSCOT WEIGHT

E.P. ELECTRIC PA EQUIP EQUIPMENT

EXH EXHAUST EXP EXPOSED EXT EXTERIOR

ELECTRIC PANEL

E.W.C. ELECTRIC WATER COOLER

POUND

LIVE LOAD LIGHT LINTEL LOCKER

LOW POINT LOUVER

LACQ LACQUER

LAMINATED VENEER LUMBER

CALIFORNIA TAHOE EMERGENCY SERVICES OPERATIONS AUTHORITY

03.21.24 - PHASE II EXPANSION _Building Department Submittal PC1 & GC RFI



POSED BUILDING STATISTICS				Sheet	
				Number	Sheet Name
CUPANCY: R-2 ISTRUCTION TYPE: V-B				G0.0 G0.1	TITLE SHEET CODE DATA SHEET
POSED BUILDING HEIGHT: EXIST				G0.2	LIFE SAFETY PLAN
POSED GROSS AREA: 6,510 SQ.	FT.			G1.1	2022 CAL GREEN CODE
POSED BUILDING STORIES ABOV	E GRADE PLANE	<u>:</u> : 1		G1.2	2022 CAL GREEN CODE
CUPANT LOAD = 43 PPL				G1.3 G1.4	2022 CAL GREEN CODE ACCESSIBILITY NOTES
NDPIPES: NOT REQUIRED				G1.5	ACCESSIBILITY DETAILS - MANEUVERABILITY ACCESSIBILITY DETAILS - SIGNAGE
				G1.6 C1.0	TITLE SHEET
E SPRINKLERS: NONE				C1.1	NOTES SHEET
				C2.1	TEMPORARY BMP'S AND DEMO PLAN
SAFETY SYSTEM REQUIREMENT	rs			C3.1 C4.1	SITE PLAN GRADING PLAN
RGENCY LIGHTING	YES			C5.1	UTILITY PLAN
SIGNS	YES			C5.2	UTILITY PLAN
E ALARM	YES			C6.1	BMP PLAN
OKE DETECTION SYSTEMS	YES			C7.1	FIRE DEFENSIBLE SPACE PLAN
THE DETECTION STOTEINS	YES			C8.1 C8.2	DETAILS DETAILS
				C8.3	DETAILS
E INFORMATION				C8.4	DETAILS
PE IIVI OTIMINTIOIV				A1.0	ARCHITECTURAL SLAB PLAN
2 CALIFORNIA BUILDING CODE				A1.1	ARCHITECTURAL EXISTING AND DEMO FLOOR PLAN
2 CALIFORNIA PLUMBING CODE				A1.2 A1.5	ARCHITECTURAL PROPOSED FLOOR PLAN ARCHITECTURAL REFLECTED CEILING PLAN
2 CALIFORNIA PLUMBING CODE				A1.6	ARCHITECTURAL PROPOSED ROOF PLAN
2 CALIFORNIA MECHANICAL CODE				A1.7	ARCHITECTURAL PROPOSED CARPORT FLOOR PLANS
2 CALIFORNIA ELECTRICAL CODE				A2.0	ELEVATIONS - WEST & SOUTH
2 CALIFORNIA FIRE CODE				A2.1 A2.2	ELEVATIONS - EAST & NORTH ELEVATIONS - CARPORT
	ODE			A4.1	INTERIOR ELEVATIONS
2 CALIFORNIA GREEN BUILIDNG C				A4.2	INTERIOR ELEVATIONS
2 CALIFORNIA BUILDING ENERGY	EFFICIENCY STA	ANDARDS		A4.3	INTERIOR ELEVATIONS
OE REGIONAL PLANNING AGENC	Y - CODE OF OR	DINANCE		A4.4	INTERIOR ELEVATIONS
				A5.0 A5.1	ASSEMBLIES BUILDING SECTIONS
Aroa Soh	edule (Gross Build	dina)		A5.2	BUILDING SECTIONS
	`			A5.3	BUILDING SECTIONS
Name	Comments	Number	Area	A5.4	BUILDING SECTIONS EXTERIOR DETAILS
NG AREA	EXISTING	R-2	1862 SF	A5.5 A5.6	EXTERIOR DETAILS EXTERIOR DETAILS
STING			1862 SF	A5.7	WALL SECTIONS
RAGE	PROPOSED	S-1	1986 SF	A6.0	DOORS AND WINDOWS
MIN AREAS YUSE ROOM	PROPOSED PROPOSED	B R-2	2189 SF 473 SF	S1.1	STRUCTURAL TITLE SHEET
POSED	PHOPOSED	N-2	4648 SF	S1.2 S2.1	STRUCTURAL SPECIFICATIONS STRUCTURAL FOUNDATION AND ROOF FRAMING PLAN
AL SQUARE FOOTAGE			6510 SF	S2.2	ROOF FRAMING PLAN
				S3.1	STRUCTURAL DETAILS
				S3.2	STRUCTURAL DETAILS
				S3.3 M0.1	STRUCTURAL DETAILS MECHANICAL SPECIFICATION, LEGEND, AND GENERAL NOTES
				M0.1	MECHANICAL SCHEDULE MECHANICAL SCHEDULE
				M0.3	MECHANICAL T-24 FORMS
				M0.4	MECHANICAL T-24 FORMS
				M2.1	MECHANICAL DEMOLITION FLOOR PLAN
				M2.1-	MECHANICAL FLOOR PLAN
				M2.2 M3.1	MECHANICAL ROOF PLAN MECHANICAL DETAILS
				P0.1	PLUMBING GENERAL NOTES, 2019 CALGREEN, SPECIFICATIONS, LEGENIAND SYMBOLS
				P0.2	PLUMBING SCHEDULES
				P0.3	PLUMBING T-24 FORMS
				P2.0	PLUMBING DEMO PLAN
				P2.1	PLUMBING WATER AND GAS LAYOUT
				P2.2	PLUMBING SEWER AND VENT LAYOUT PLUMBING ROOF PLAN
				P2.3 P3.1	PLUMBING SCHEMATIC DIAGRAM
				P4.1	PLUMBING DETAILS
				E1.0	ELECTRICAL GENERAL NOTES, LEGEND AND SYMBOLS
				E2.0	ELECTRICAL TITLE 24 INTERIOR
				E2.1	ELECTRICAL POWER AND SIGNAL BLAN
				E3.0 E3.1	ELECTRICAL POWER AND SIGNAL PLAN ELECTRICAL ROOF PLAN
				E4.0	ELECTRICAL LIGHTING PLAN
				E5.0	ELECTRICAL SINGLE LINE DIAGRAM AND PANEL SCHEDULE
				E6.0	ELECTRICAL DETAILS
				F7.0	FLECTRICAL SPECIFICATIONS

E7.0 ELECTRICAL SPECIFICATIONS

SHEET INDEX



530.542.2919

Drawn By BM-BM

95% CD PHASE

Project Number 211008

TRPA _ BID_ SUBMITTAL

ELDO COUNTY BUILDING

04.21.2023

G0.0

Location of doors equipped with hold-open devices

ACCESSIBLE PARKING (SECTION 11B-208)

TOTAL PARKING SPACES		L# OF G SPACES	# OF ACCESSIBLE SPACES PROVIDED				
	REQUIRED	PROVIDED	REGULAR WITH VAN SPACE		ES WITH	PROVIDED	
		5' ACCESS AISLE	5' ACCESS AISLE	60" ACCESS AISLE	108" WIDE W/ 8' ACCESS AISLE		
11	1	1	0	1	0	1	
TOTAL						1	

ENERGY SUMMARY

ENERGY REQUIREMENTS:	Entro: Johnner
•	considered minimum and any special attribute required to meet the California <mark>.</mark> Energy Code shall also
Existing building envelope co	omplies with code: No Yes (The remainder of this section is not applicable)
Exempt Building: 🗵 No	Yes (Provide Code or Statutory reference):
Climate Zone:	☑ 16
Method of Compli	innce: Energy Code Performance Prescriptive ASHRAE 90.1 Performance Prescriptive

(If "Other" specify source here) ____

THERMAL ENVELOPE (Prescriptive method only)

Roof/ceiling Assembly

Description of assembly: Asphalt Shingle/ vapor permeable felt/ plywood/ air cavity/ wood framing R-38 batt insulation/ gyp board

U-Value of total assembly: .033

R-Value of insulation: R-38

Skylight: .58 (see window/ door schedule)

Exterior Walls

Description of assembly: siding/ vapor permeable/ extruded polystyrene XPS/ wood framed wall/ gypsum bd.
U-Value of total assembly: .048
R-Value of insulation: R-21
Openings (windows or doors with glazing)
U-Value of assembly: .36
Solar heat gain coefficient: .25
Door U-Values: .45

No Frontage Area Increases Taken:

STORY NO.	DESCRIPTION AND USE	(A) BLDG AREA PER STORY (ACTUAL)	(B) TABLE 506.2 ⁴ AREA	(C) AREA FOR FRONTAGE INCREASE ^{1,5}	(D) ALLOWABLE AREA PER STORY OR UNLIMITED ^{2,3}
\vdash					

Frontage area increases from Section 306.3 are computed thus:

- Perimeter which fronts a public way or open space having 20 feet minimum width = ______(F)
 Total Building Perimeter = _____(P)
- c. Ratio (F/P) = _____ (F/P)

 d. W = Minimum width of public way = _____ (W)

 e. Percent of frontage increase N = 100 [F/P 0.25] x W/30 = _____ (%)
- Unlimited area applicable under conditions of Section 507.

 Maximum Building Area = total number of stories in the building x D (maximum 3 stories) (506.2).
- The maximum area of open parking garages must comply with Table 406.3.4

 Frontage increase is based on the unsprinklered area value in Table 506.2.

ALLOWABLE HEIGHT - R-2 (MOST RESTRICTIVE)

	ALLOWABLE (TABLE 503)	SHOWN ON PLANS	CODE REFERENCE
Height in Feet (Table 504.3)	60'	26'-8"	(R-2) W/O Area Increase. Sprinklered
Height in Stories (Table 504.4)	3	3	(R-2) W/O Area Increase. Sprinklered

FIRE PROTECTION REQUIREMENTS- TYPE V-B

BUILDING ELEMENT	FIRE SEPARATION DISTANCE	RATING		DETAIL# AND SHEET#	DESIGN # FOR RATED ASSEMBLY	
	(FEET)	agg'o	PROVIDED (W/* REDC)			
Structural Frame, including columns, girders, trusses		0	0	NA	NA.	
Bearing Walls						
Exterior						
North		0**	0	B/A5.1	INTERTEK LPB/WA 60-01 UL 340	
East		0**	0	B/A5.1	INTERTEK LPB/WA 60-01 UL 340	
West		0**	0	B/A5.1	INTERTEK LPB/WA 60-01 UL 340	
South		0**	0	B/A5.1	INTERTEK LPB/WA 60-01 UL 340	
Interior (BEARING)		0	0	A/A5.1		
Nonbearing Walls and				C/A0-100		
Partitions						
Exterior walls						
North		N/A**				
East		N/A**				
West		N/A**				
South		N/A**				
Interior walls and partitions		0	0			
Column Supporting Floors	1	0	0			
Roof Construction, including		0	0		,	
supporting beams and joists						
Roof Ceiling Assembly		0	0		*	
Column Supporting Roof		0	0	'		
Shaft Enclosures - Elevator 703.2.1		1	1	A/A5.1	UL 340	
Incidental Use Separation		1	1	A/A5.1	BXUV.V340	

**Exterior elements including walls, floor projections, roofs, windows and doors shall all comply with CBC Ch 7A.

LIFE SAFETY SYSTEM REQUIREMENTS

Emergency Lighting:	☐ No 🛛 Yes
Exit Signs:	No ⊠ Yes
Fire Alarm:	☐ No ⊠ Yes
Smoke Detection Systems:	☐ No 🛛 Yes
Carbon Monoxide Detection:	☐ No 🛛 Yes

LIFE SAFETY PLAN REQUIREMENTS

Life Safety Plan Sheet #: G0.2

Fire and/or smoke rated wall locations (Chapter 7)

Assumed and real property line locations (if not on the site plan)

Exterior wall opening area with respect to distance to assumed property lines (705.8)
 Occupancy types for each area as it relates to occupant load calculation (Table 1004.5)

Occupant loads for each area

Exit access travel distances (1017)
Common path of travel distances (1006.2.1 & 2006.3.2(1))

2022 CODE FOR:

New Construction

1st Time Interior Completion

Shell/Core
Phased Construction – Shell/Core
Renovation

2022 BUILDING CODE:

 ≥ 2022 California Building Code (CBC)
 ≥ 2022 California Fire Code (CFC)
 ≥ 2022 California Plumbing Code (CPC)
 ≥ 2022 California Mechanical Code (CMC)
 ≥ 2022 California Green Code (CFC)
 ≥ 2022 California Green Code (CFC)
 ≥ 2022 Residential and Non Residential Energy Standards (T24 INC)
 ≥ CSLT City Ordinances and State Laws
 ≥ 2022 California Building Code (CBC) CH 11B

2022 CBC EXISTING BUILDING CODE: Prescriptive Repair Chapter 14

BASIC BUILDING DATA

Special Inspections Required: No Yes See Structural Plans for More Information

Fire Hazard Area: Very High Fire Severity Zone - CBC CH. 7A Applicable

Gross Building Area:

	В	S-1	R-2	
	Accessory	Accessory		
Building - Ground Flr.	2,189 sq.ft.	1,986 sq.ft.	2,335 sq.ft.	6,510 sq.ft.
Total			Max Area of Building: As=[At + (NS x If]] x Sa 7,000 sq.ft. + (7,000) * 0]] * 3 =14,000 Max Area Per Story: As=[At + (NS x If]] x Sa 7,000 sq.ft. + (7,000) * 0]] * 1 =7,000	Total Area: 6,510 sq.ft. (PERTABLE 996.2 SM/VB/ MAX AREA 34,000 SQ.FT. SOC.2.1) W/ HEIGHT INCREASE SOLA

TOTAL GROSS AREA INCLUDES COVERED EXTERIOR WALKS, COVERED BALCONIES AND DECKS.

PER 508.3.2 THE ALLOWABLE BUILDING AREA, HEIGHT AND NUMBER OF STORIES OF THE BUILDING OR PORTION THEREOF SHALL BE BASED ON THE MOST RESTRICTIVE ALLOWANCES FOR THE OCCUPANCY GROUPS UNDER CONSIDERATION FOR THE TYPE OF CONSTRUCTION OF THE BUILDING IN ACCORDANCE WITH SECTION 503.1.

BOTH TO UTILIZE MORE RESTRICTIVE R-1 USE.

Mixed Occupancy:

Non-Separated Use (508.3)

The required type of construction for the building shall be determined by applying the height and area limitations for each of the applicable occupancies to the entire building. The most restrictive type of construction, so determined, shall apply to the entire building.



SOUTH LAKE TAHOE CA. 96150

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TAHOE EMERGENCY SERVICES OPERATIONS AUTHORIT

Drawn By BM-BM

Project Number 211008

Date 04.21.2023

95% CD PHASE


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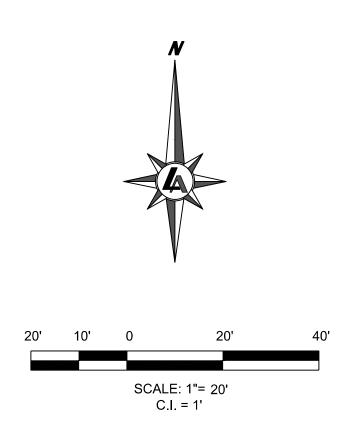
 1
 TRPA _ BID_ SUBMITTAL
 04.21.23

 2
 BID SET II
 07.07.23

 3
 ELDO COUNTY BUILDING DEPT PC1
 02.20.24

G0.1



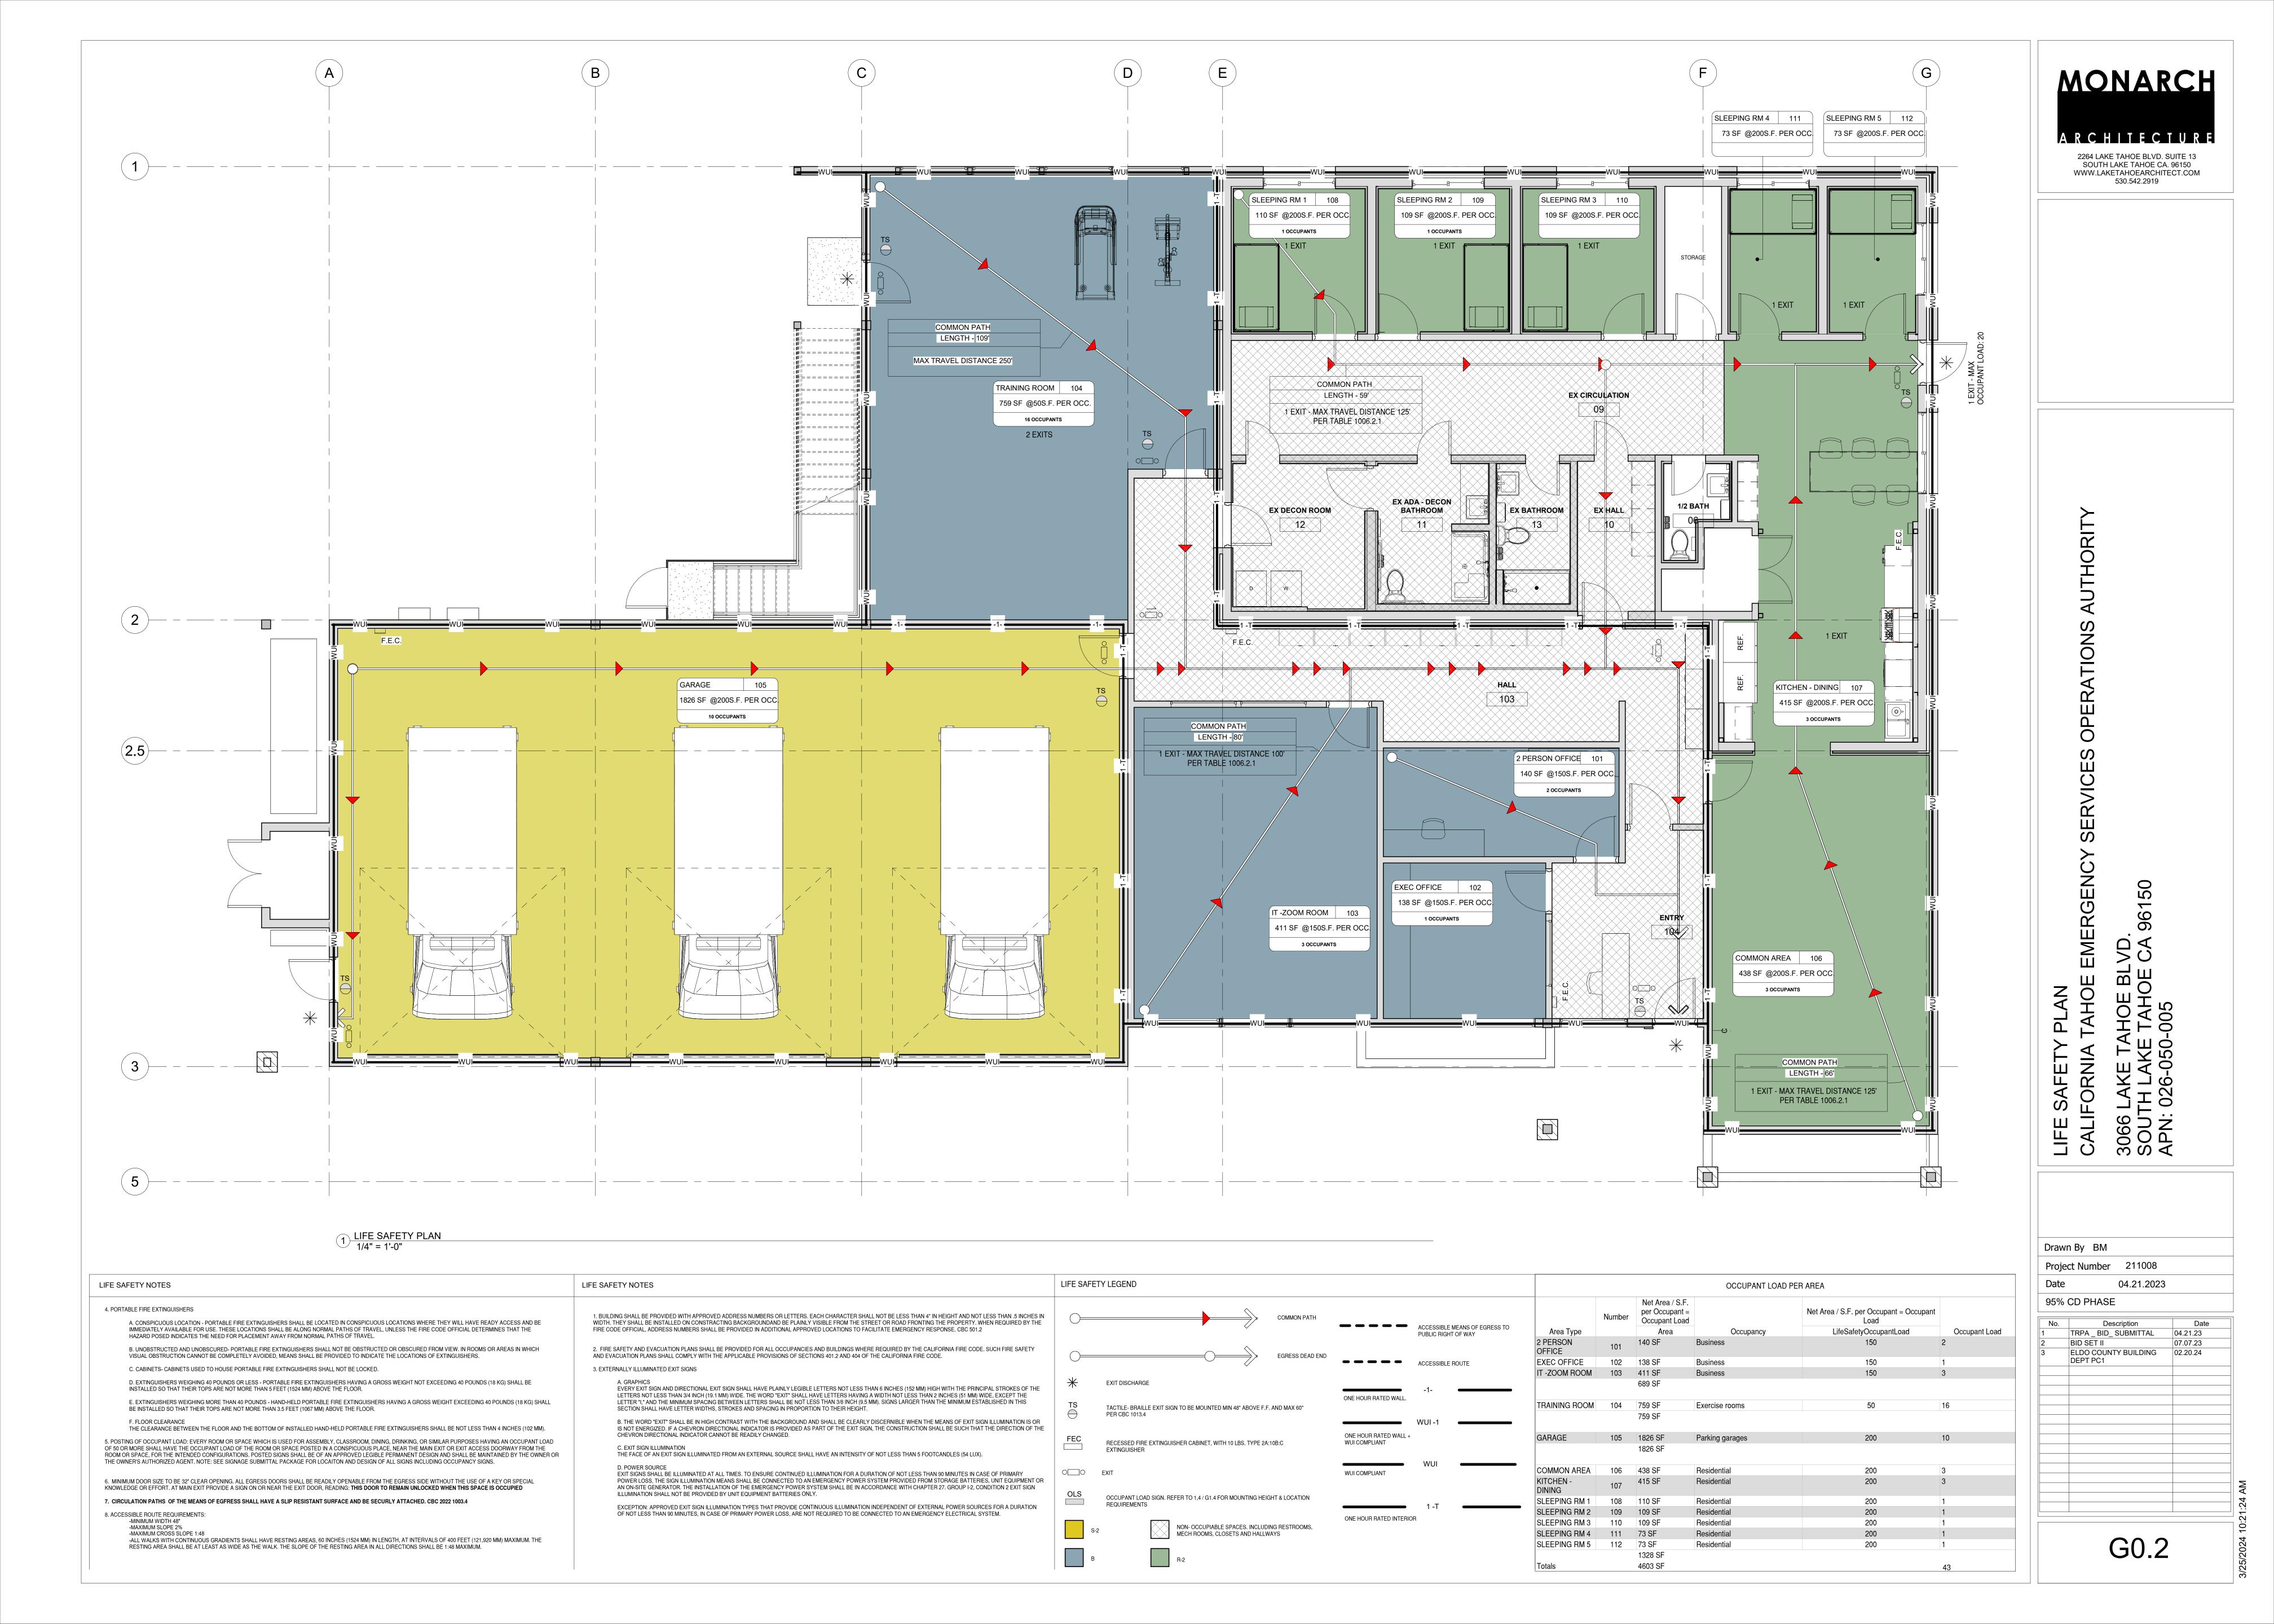



REFERENCES

R1) RECORD OF SURVEY, FILED IN BOOK 16 AT PAGE 30, ON NOVEMBER 16, 1988, OFFICIAL RECORDS OF EL DORADO COUNTY, STATE OF CALIFORNIA.

NOTES

1) THIS SHEET IS PROVIDED FOR INFORMATION ONLY, SHOWING EXISTING CONDITIONS AT THE TIME OF SURVEY AND NOT A PART OF DESIGN REVIEW.

- 2) FIELD WORK WAS PERFORMED ON JULY 6 & 7, 2022.
- 3) EASEMENTS MAY EXIST THAT ARE NOT SHOWN HEREON
- 4) THIS IS NOT A BOUNDARY SURVEY. RIGHT OF WAY SHOWN BY RECORD INFORMATION.

SITE INFORMATION:

A.P.N. 026-050-005-000 3050 LAKE TAHOE BLVD. (BUILDING ADDRESS 3066 LAKE TAHOE BLVD.) EL DORADO COUNTY, CALIFORNIA 35 ACRES

DATUM STATEMENT

THE HORIZONTAL COORDINATES AND BASIS OF BEARINGS FOR THIS PROJECT IS BASED UPON THE CALIFORNIA SPATIAL REFERENCE SYSTEM, NAD83 (1991.35), CCS 83 ZONE 2. ELEVATIONS ARE BASED ON NORTH AMERICAN VERTICAL DATUM OF 1988 (NAVD 1988). THE DATUM WAS DETERMINED BY REFERENCING RECORD OF SURVEY BOOK 34, PAGE 76, RECORDED ON FEBRUARY 9TH, 2015 BY THE CALIFORNIA DEPARTMENT OF TRANSPORTATION. NAVD88 ELEVATIONS PER OUR SURVEY WERE DETERMINED BY APPLYING A NGS NORTH AMERICAN VERTICAL DATUM CONVERSION (VERTCON) TO THE PUBLISHED NGVD29 ELEVATIONS.


ALL DIMENSIONS ON THIS MAP ARE GROUND DISTANCES.


PROPERTY OWNER:

EL DORADO COUNTY 360 FAIR LANE PLACERVILLE, CA 95667

PROJECT CONTROL						
POINT NO.	NORTHING	EASTING	ELEVATION	DESCRIPTION		
557	2111430.22	7139678.08	6264.96	CP 5/8 REBAR CONTROL CAP		
558	2111600.41	7139675.50	6264.06	CP 5/8 REBAR CONTROL CAP		
560	2111496.81	7139876.38	6264.66	CP 5/8 REBAR CONTROL CAP		
561	2111627.45	7139845.36	6263.13	CP 5/8 REBAR CONTROL CAP		

LEGEND:

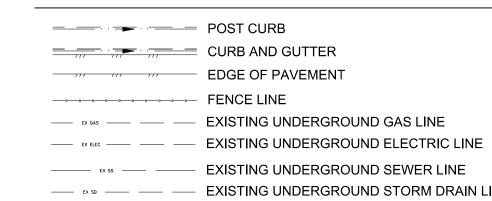

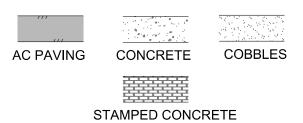

- WV WATER VALVE
 WM□ WATER METER
- wso WATER SPICKET / HOSE BIB
- ICV IRRIGATION CONTROL VALVE
 ICB□ IRRIGATION CONTROL BOX
- w□ WATER VAULT

 ∀ FIRE HYDRANT
- S SANITARY SEWER MANHOLE
- STORM DRAIN CATCH BASIN
 CB COMMUNICATION BOX
- GM □ GAS METER
- EV ELECTRIC VAULT
- EB : ELECTRIC PANEL

 EB : ELECTRIC BOX

- TREE "@BH D=DECIDUOUS
- TREE "@BH D=DECIDUOUS

 A LUMOS CONTROL POINT
 - LOMOS CONTINOL I CINI

LUMOS & ASSOCIATES

312 DORLA COURT, SUITE 202 ZEPHYR COVE, NV 89448 TEL: 775.588.6490

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AMBULANCE BUILDING 3066 LAKE TAHOE BLVD. TOPOGRAPHIC MAP

REV DATE DESCRIPTION BY

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DESIGNED BY:
CHECKED BY: MBC
JOB NO.: 10723.000
SHEETS: 1 OF 1


L: \LAFTO\\10/23.000 — C1ESOA Ambulance Building\Survey\DWG\10/23000 Survey.awg,10FO, 08/10/2022 03:47 pm mcraven NOTES:

1. THE CONTRACTOR MAY ADJUST THE LOCATION OF THE CONSTRUCTION STAGING AREA AND CONCRETE WASHOUT AS NECESSARY FOR SITE CONDITIONS.

- 2. PEDESTRIAN PROTECTION MUST BE MAINTAINED AND KEPT IN GOOD ORDER THROUGHOUT THE ENTIRE PROJECT. UPON COMPLETION, THE OWNER OR OWNER'S REPRESENTATIVE SHALL IMMEDIATELY REMOVE WALKWAYS, DEBRIS AND OTHER OBSTRUCTIONS AND LEAVE PUBLIC PROPERTY IN AS GOOD A CONDITION AS IT WAS BEFORE WORK WAS COMMENCED. 3. A PREGRADE/DEMOLITION INSPECTION SHALL BE CONDUCTED BEFORE DEMOLITION BEGINS. THIS INSPECTION SHALL VERIFY THAT THE FOLLOWING EROSION AND VEGETATION
- PROTECTION IS INSTALLED TO TRPA STANDARDS. 3.1. VEGETATION FENCING AROUND ALL TREES THAT ARE SCHEDULED TO BE PRESERVED.
- 3.2. EROSION CONTROL FENCING AROUND THE PERIMETER OF THE CONSTRUCTION SITE.
- 3.3. DUST CONTROL METHODS.
- 3.4. TAHOE REGIONAL PLANNING AGENCY (TRPA) APPROVED DEWATERING CONTAINMENT/TREATMENT SYSTEM, IF APPLICABLE. IF GROUNDWATER IS ENCOUNTERED THE CONTRACTOR SHALL STOP WORK IMMEDIATELY, PREPARE A DEWATERING PLAN AND GET APPROVAL FROM TRPA BEFORE PROCEEDING.
- 3.5. ON SITE CONTAINMENT SYSTEM FOR ANY SOURCE OF POLLUTION INCLUDING, DEMOLITION DUST, SITE GRADING DUST, LITTER, SEDIMENT, NUTRIENTS, OIL AND GREASE, ETC. MUST BE CONTAINED AND ARE SUBJECT TO FINES AND LEGAL ACTION FROM THE CITY OF SOUTH LAKE TAHOE, LAHONTAN REGIONAL WATER QUALITY CONTROL BOARD,
- 4. THE CONTRACTOR SHALL PROVIDE, PLACE, AND MAINTAIN ALL NECESSARY TRAFFIC CONTROLS.
- 5. THE CONTRACTOR SHALL BE SOLELY AND COMPLETELY RESPONSIBLE FOR COMPLIANCE WITH
- ALL APPLICABLE PROVISIONS OF OSHA. 6. CONTRACTOR SHALL PROTECT EXISTING PAVING, CONCRETE, LANDSCAPING, FENCING, MAILBOXES, SIGNS AND ANY OTHER IMPROVEMENTS NOT SPECIFICALLY CALLED OUT FOR DEMOLITION. CONTRACTOR SHALL REPAIR/REPLACE ANYTHING DAMAGED AT THEIR OWN
- 7. ALL AREAS DISTURBED SHALL BE REVEGETATED IN ACCORDANCE WITH TRPA'S BEST MANAGEMENT PRACTICES.

TREE REMOVAL TREE QUANTITY 12" 1 16" 18" 2 20" 3 22" 2 24" 30" 36" 40" 1

AC REMOVAL

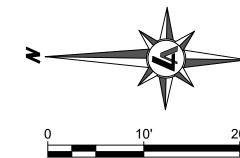




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No. 72380 Exp. 6/30/24 CIVIL ORNIT 4/02/24	
S.	

AMBULANCE BUILDING - PHASE BACK PARKING LOT IMPROVEME TEMPORARY BMPS &


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SPLIT RAIL "ZICZAG: FEWCE OF STATE OF S	22p	421 S	45.1 0 0 0 0 0 0 0 0 0 0 0 0 0 0 0 0 0 0 0
EX. WOOD POSTS TO REMAIN (TYP OF 4)	REMOVE & DISPOSE OF EX. SHED	18P	C264 REMOVE TREE (TYP)
6264 PROPOSED BUILDING LIMITS (SHOWN FOR REFERENCE) CONSTRUCTION REFERENCE)	RELOCATE EX. SHIPPING POD. COORDINATE WITH OWNER. REMOVE & DISPOSE OF EX. FENCE & RAILROAD TIE	EX. BUILDING LIMITS DEMO A DISPOSI	AND SOFT SOFT SOFT SOFT SOFT SOFT SOFT SOFT
REMOVE & DISPOSE OF EX. RAILROAD TIES (TYP OF 4) AND TREE STUMP PROTECT IN PLACE EX. CARVED BEAR STATUE	POD. COORDINATE WITH OWNER. REMOVE & DISPOSE OF EX. RAILROAD TIES (TYP OF 7)	MOVE & RELOCATE EX. AGPOLE. COORDINATE WITH OWNER. EX. ASPH CONCR EX. BOLLAI TO REMAIN	EXISTING BUILDING
EX. 6" POLES WITH WIRE STRUNG BETWEEN TO REMAIN EX. DECORATIVE GREEN BICYCLE TO REMAIN BICYCLE TO R	EX. STRIPING TO BE REMOVED (TYP) CONCRETE WASHOUT	DEMO AND DISPOSE OF EX. ASPHALT CONCRETE EX. STRIPING TO BE REMOVED	CONSTRUCTION EX. RAILROAD TIES TO REMAIN (TYP)
RIGHT OF WAY EX. USFS FIRE SIGN TO REMAIN	CONSTRUCTION FENCING (TYP) C8.1 SS X3	C. BACKFLOW PREVENTER EX. BUS SHELTER SS X3 SS X3	SS X3
≥x x≥	OS X3	EX IRRO	

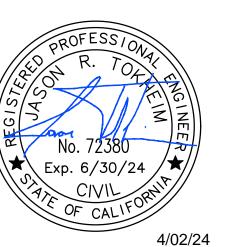



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A/02/24 A/02/24

AMBULANCE BUILDING - PHASACK PARKING LOT IMPROVENSITE PLAN

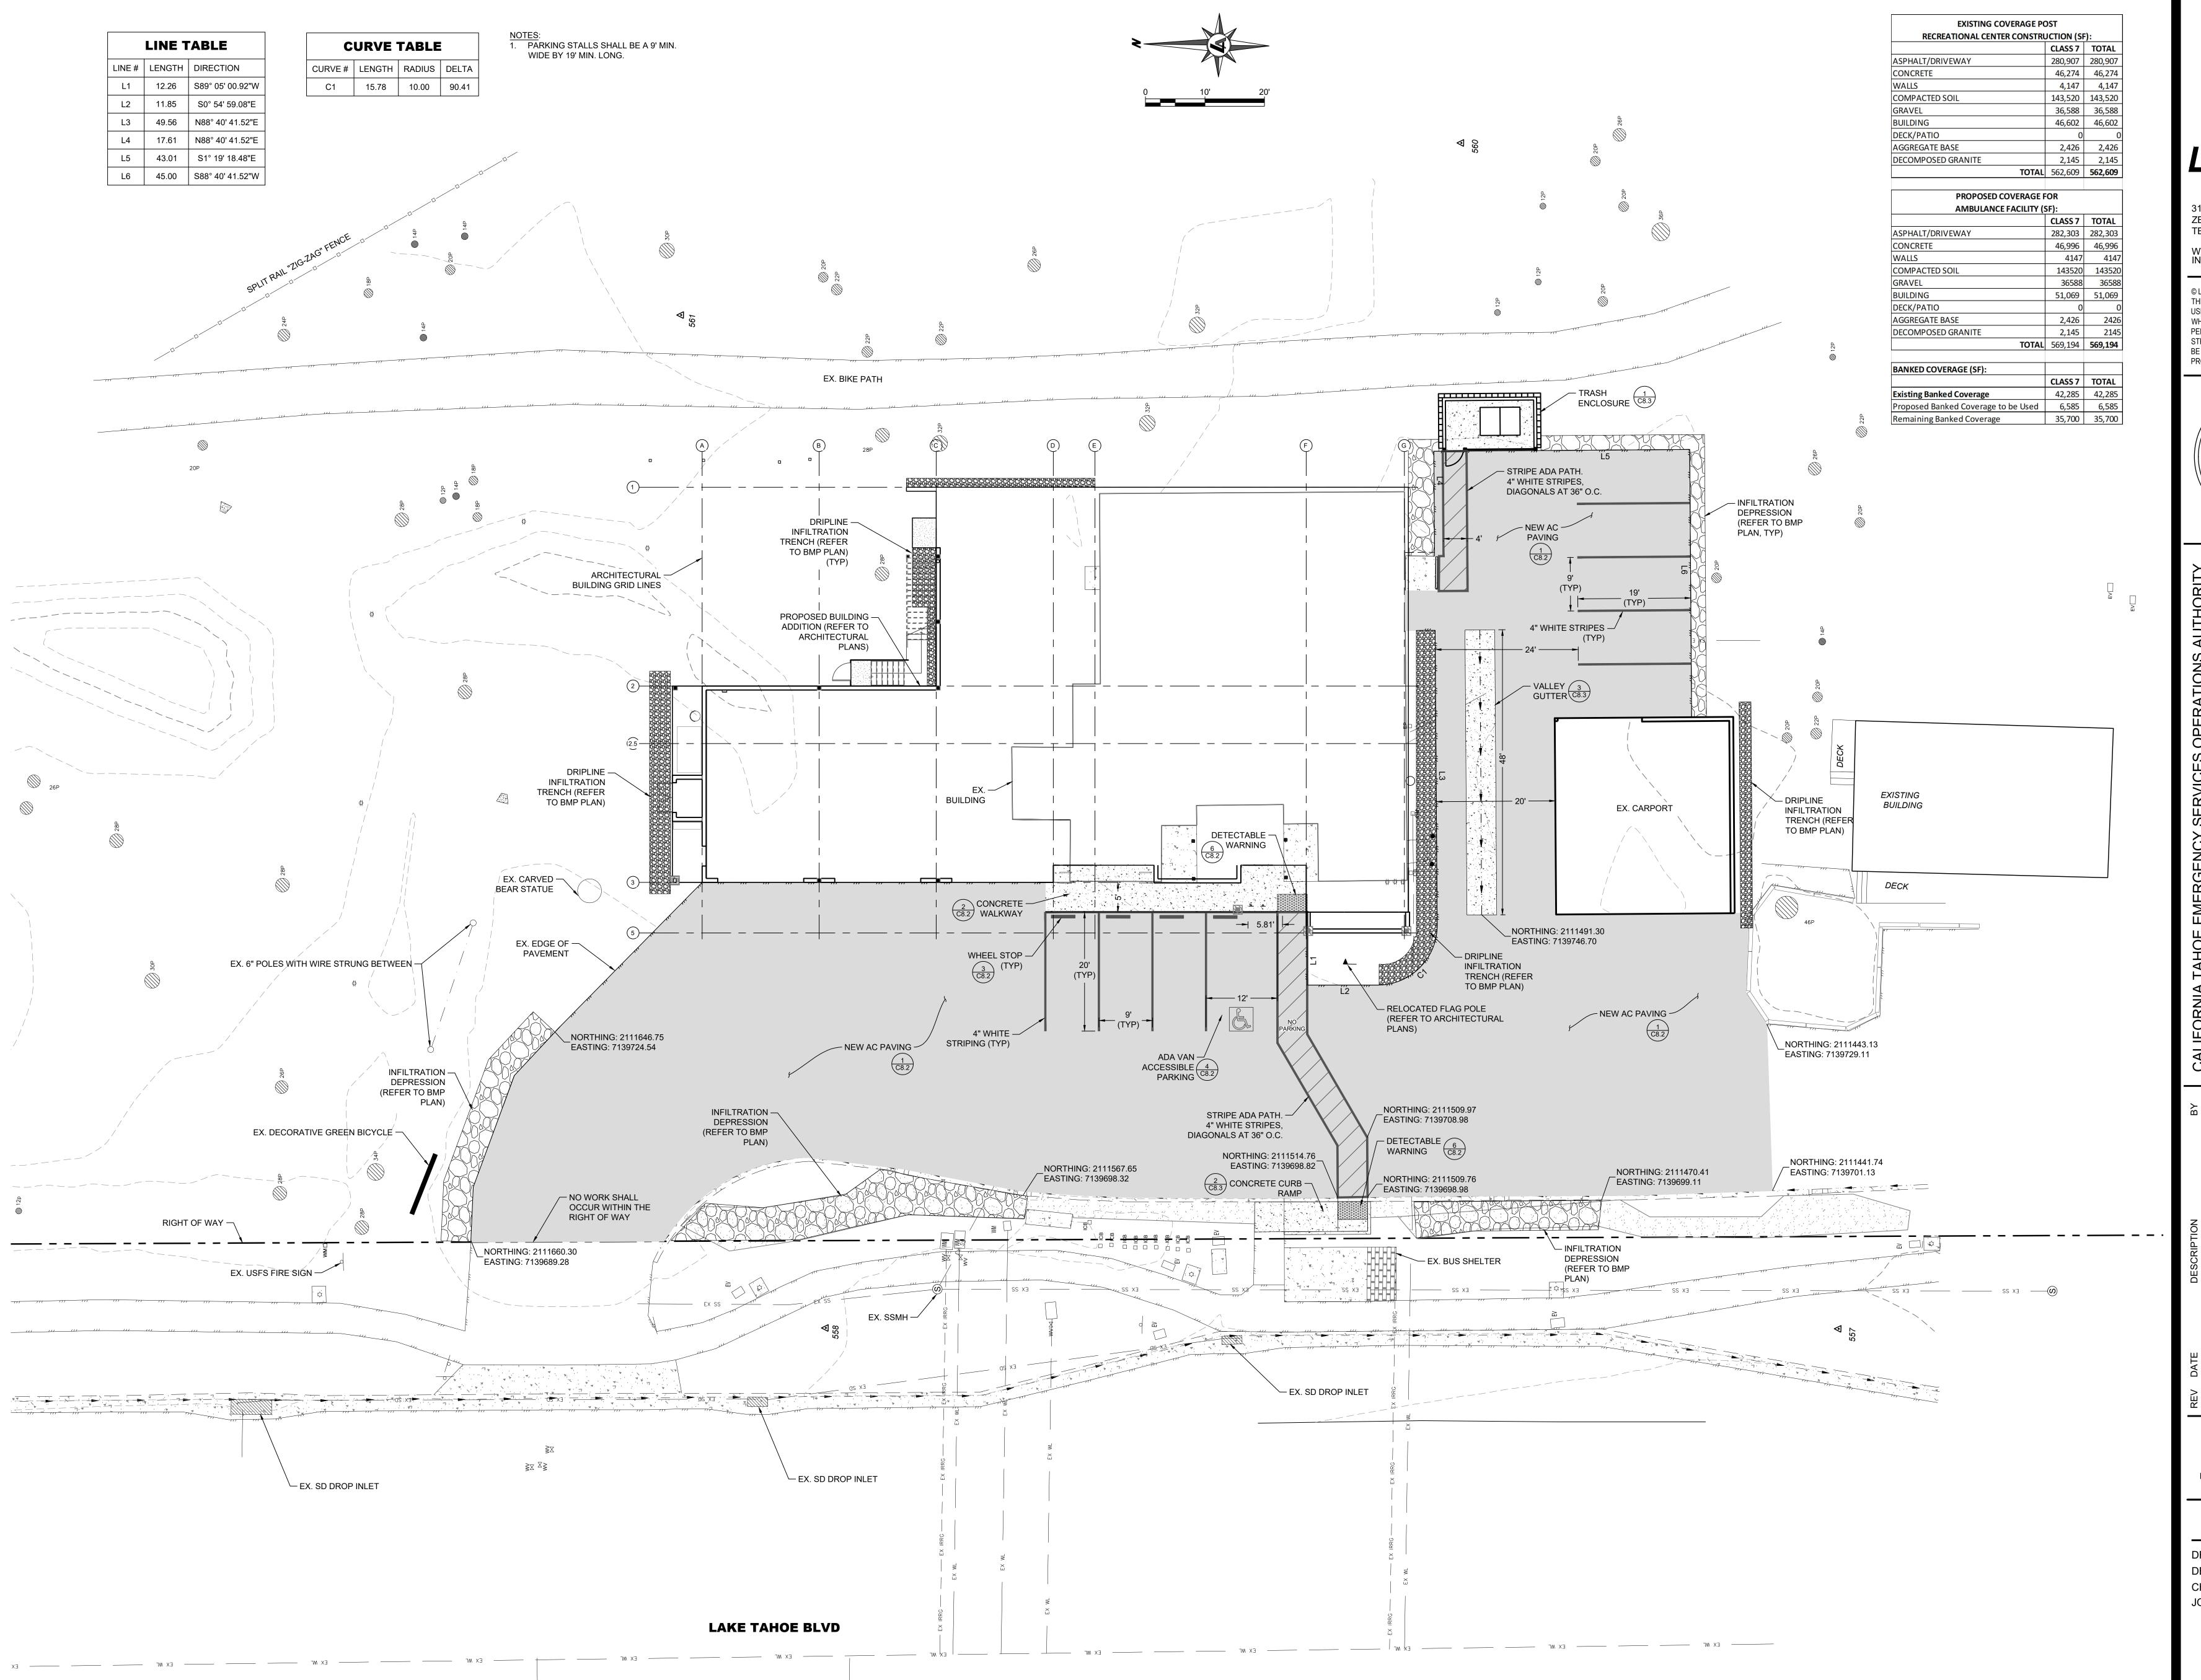
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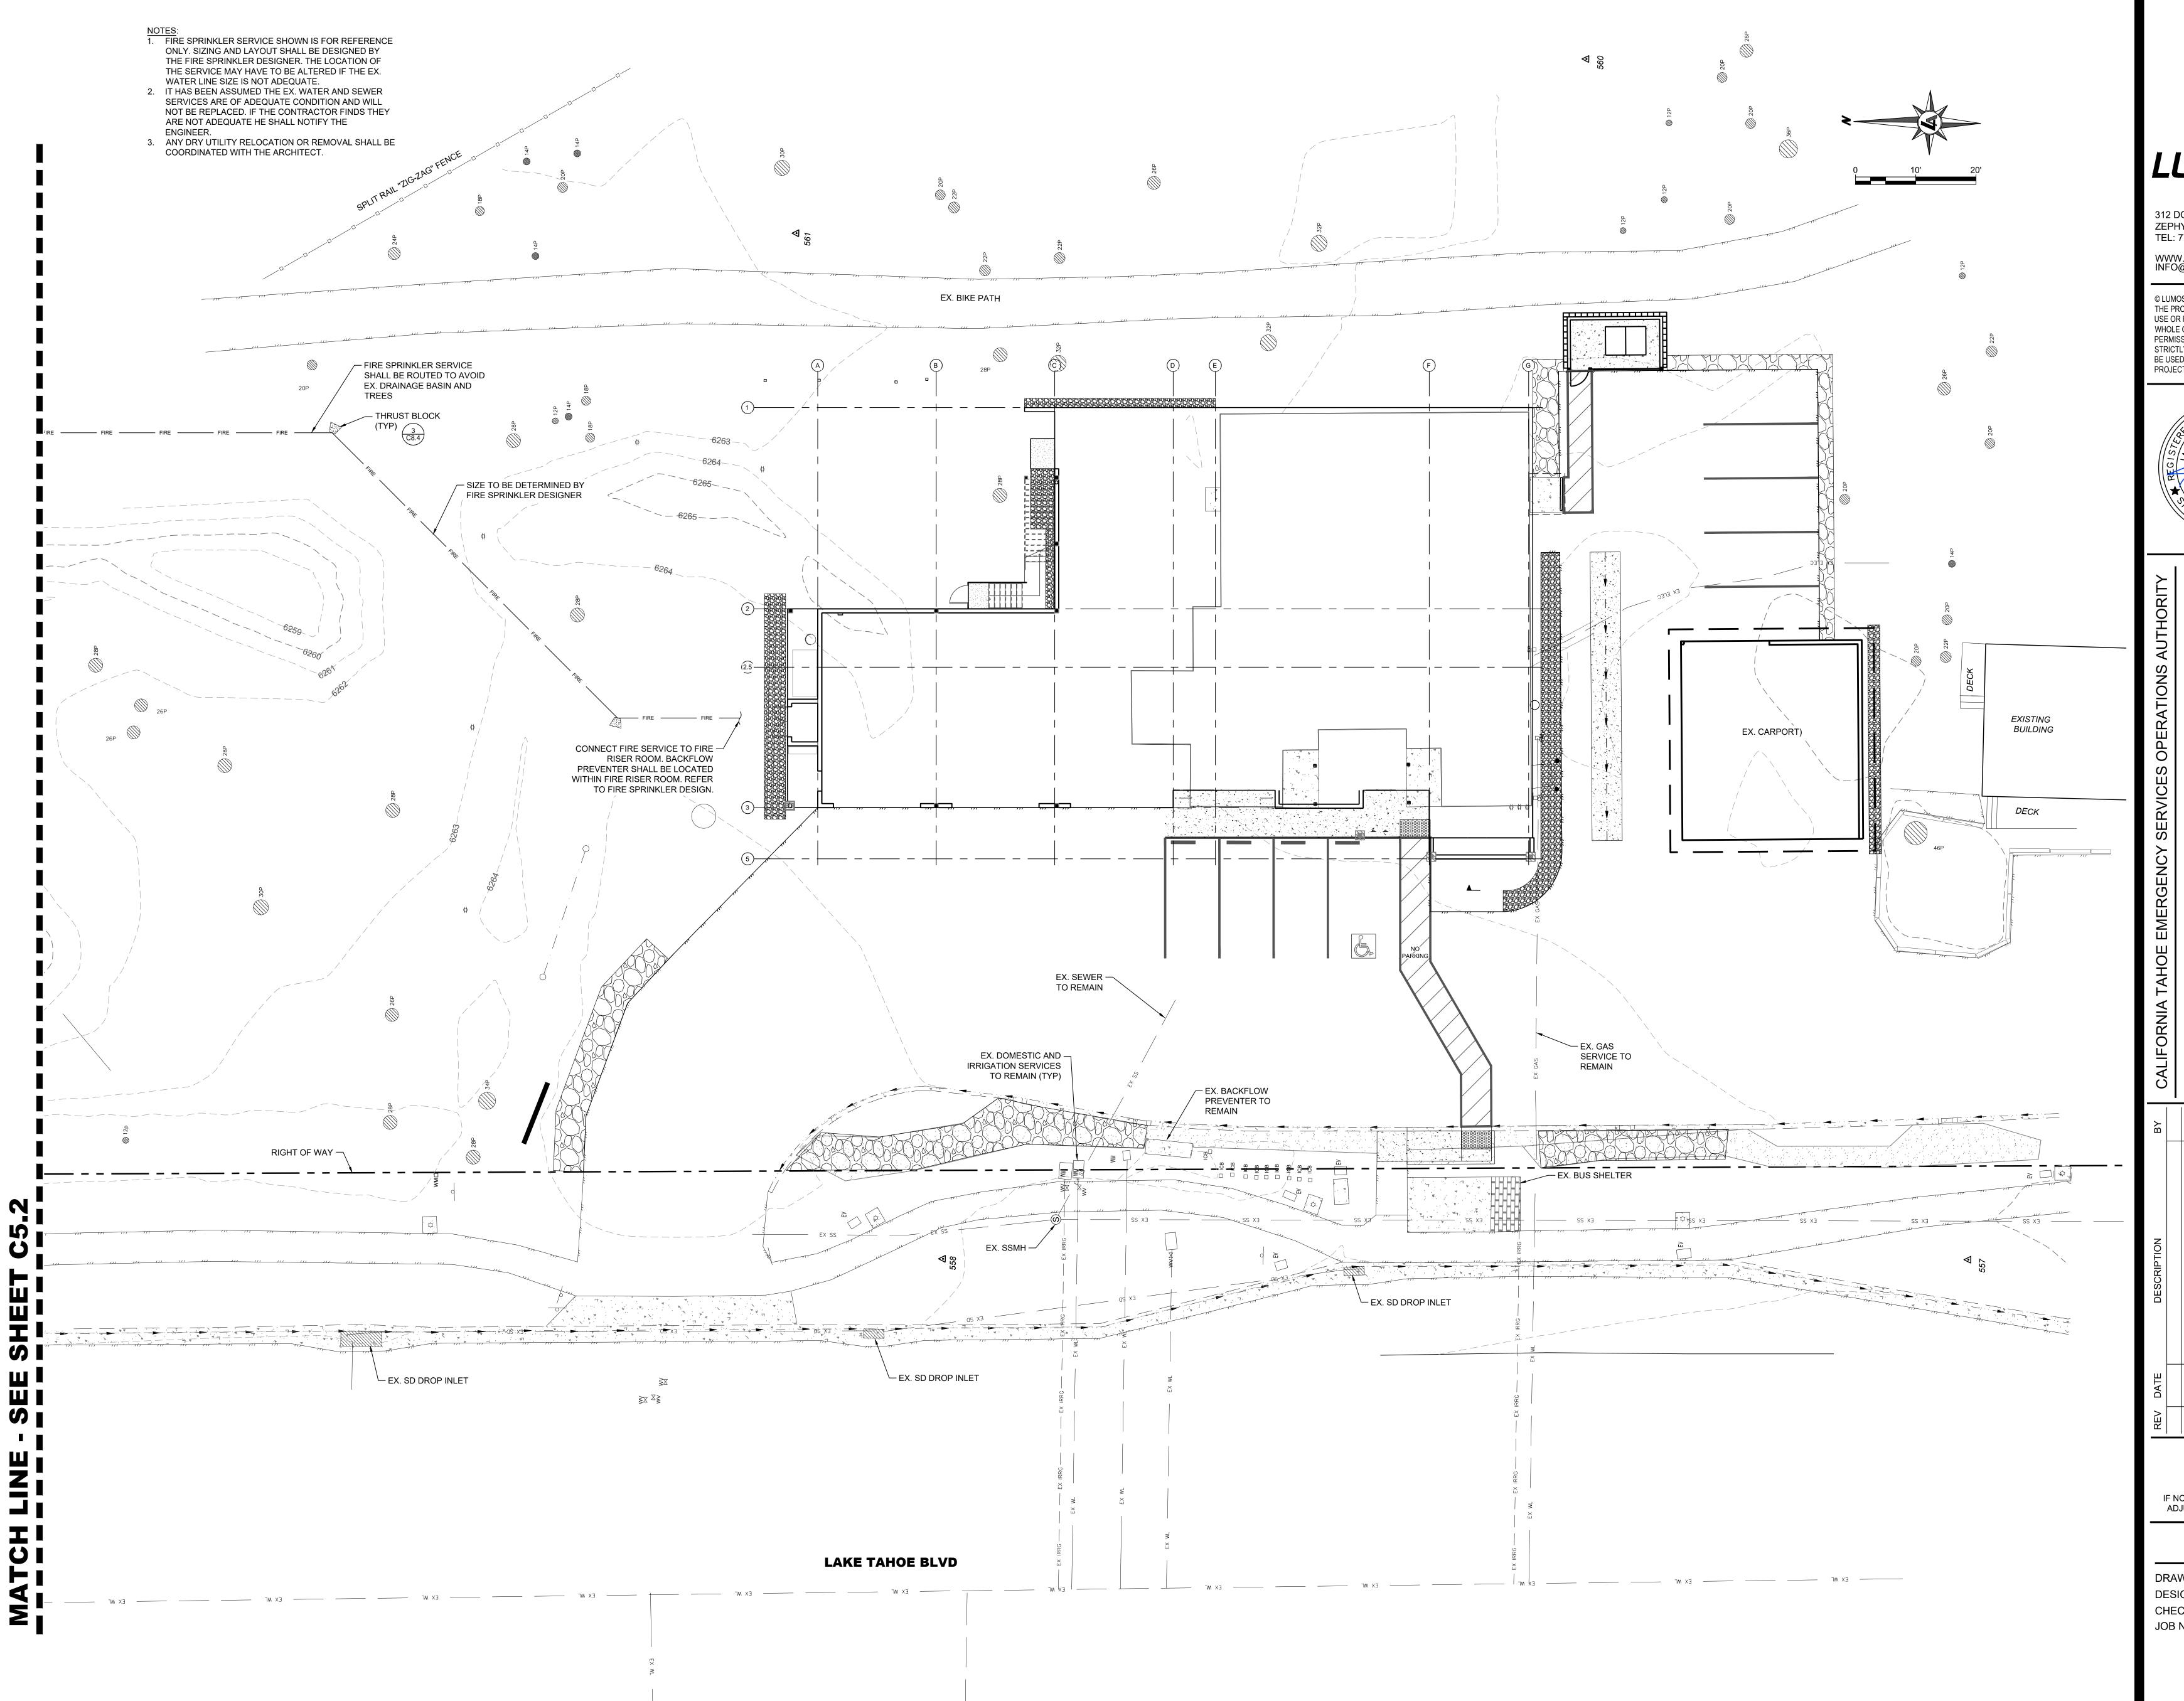
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AMBUL


BAR IS 1 INCH ON ORIGINAL DRAWING

ADJUST SCALES ACCORDINGLY

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NOTES:


1. FIRE SPRINKLER SERVICE SHOWN IS FOR REFERENCE ONLY. SIZING AND LAYOUT SHALL BE DESIGNED BY THE FIRE SPRINKLER DESIGNER. THE LOCATION OF THE SERVICE MAY HAVE TO BE ALTERED IF THE EX. WATER LINE SIZE IS NOT ADEQUATE. - <u>NOTE</u>: SURVEY TOPO WAS -NOT OBTAINED BEYOND DETENTION BASIN LIMITS EX. 6" STEEL WATERLINE.
CONTRACTOR SHALL FIELD
VERIFY. CUT-IN NEW FIRE SERVICE $\frac{4}{C8.4}$ FIRE SPRINKLER SERVICE
SHALL BE ROUTED TO AVOID
EX. DRAINAGE BASIN AND
TREES SIZE TO BE DETERMINED BY FIRE SPRINKLER DESIGNER THRUST BLOCK — (TYP) WATERLINE TRENCH $\frac{5}{C8.4}$ HIGHWAY RIGHT-OF-WAY LAKE TAHOE BLVD

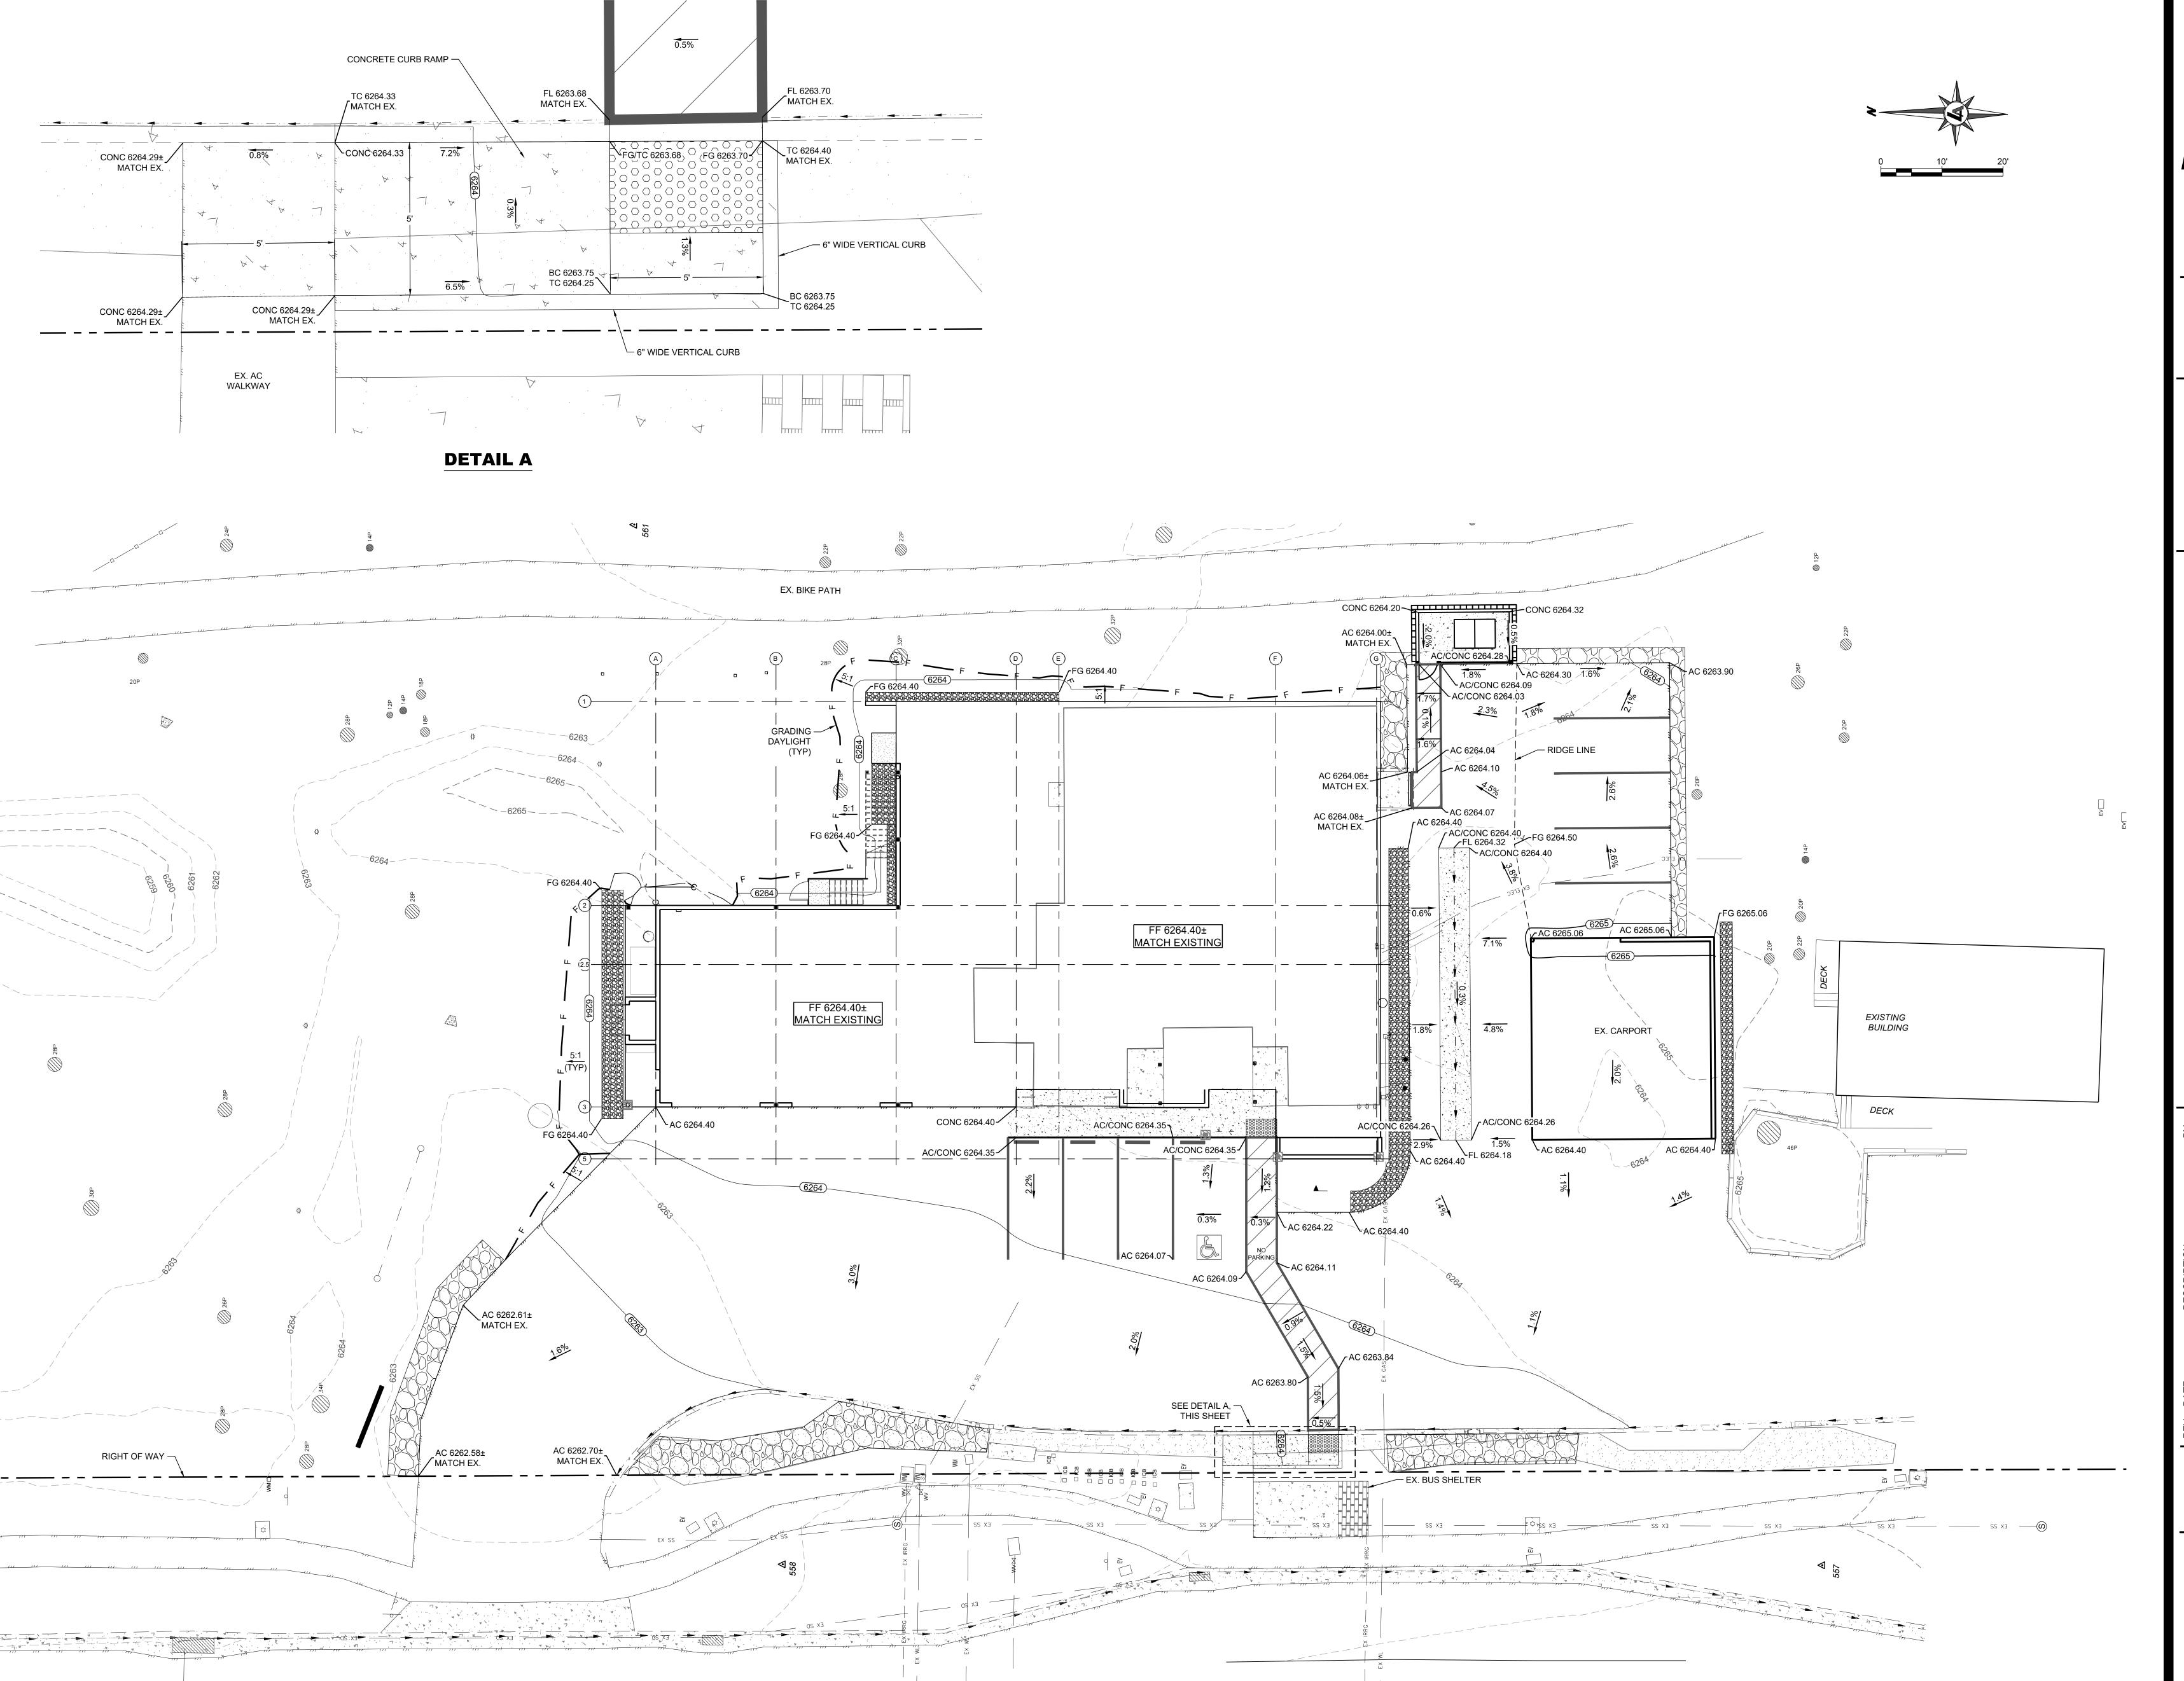
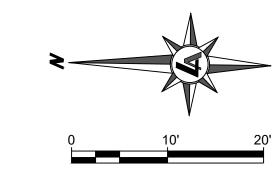
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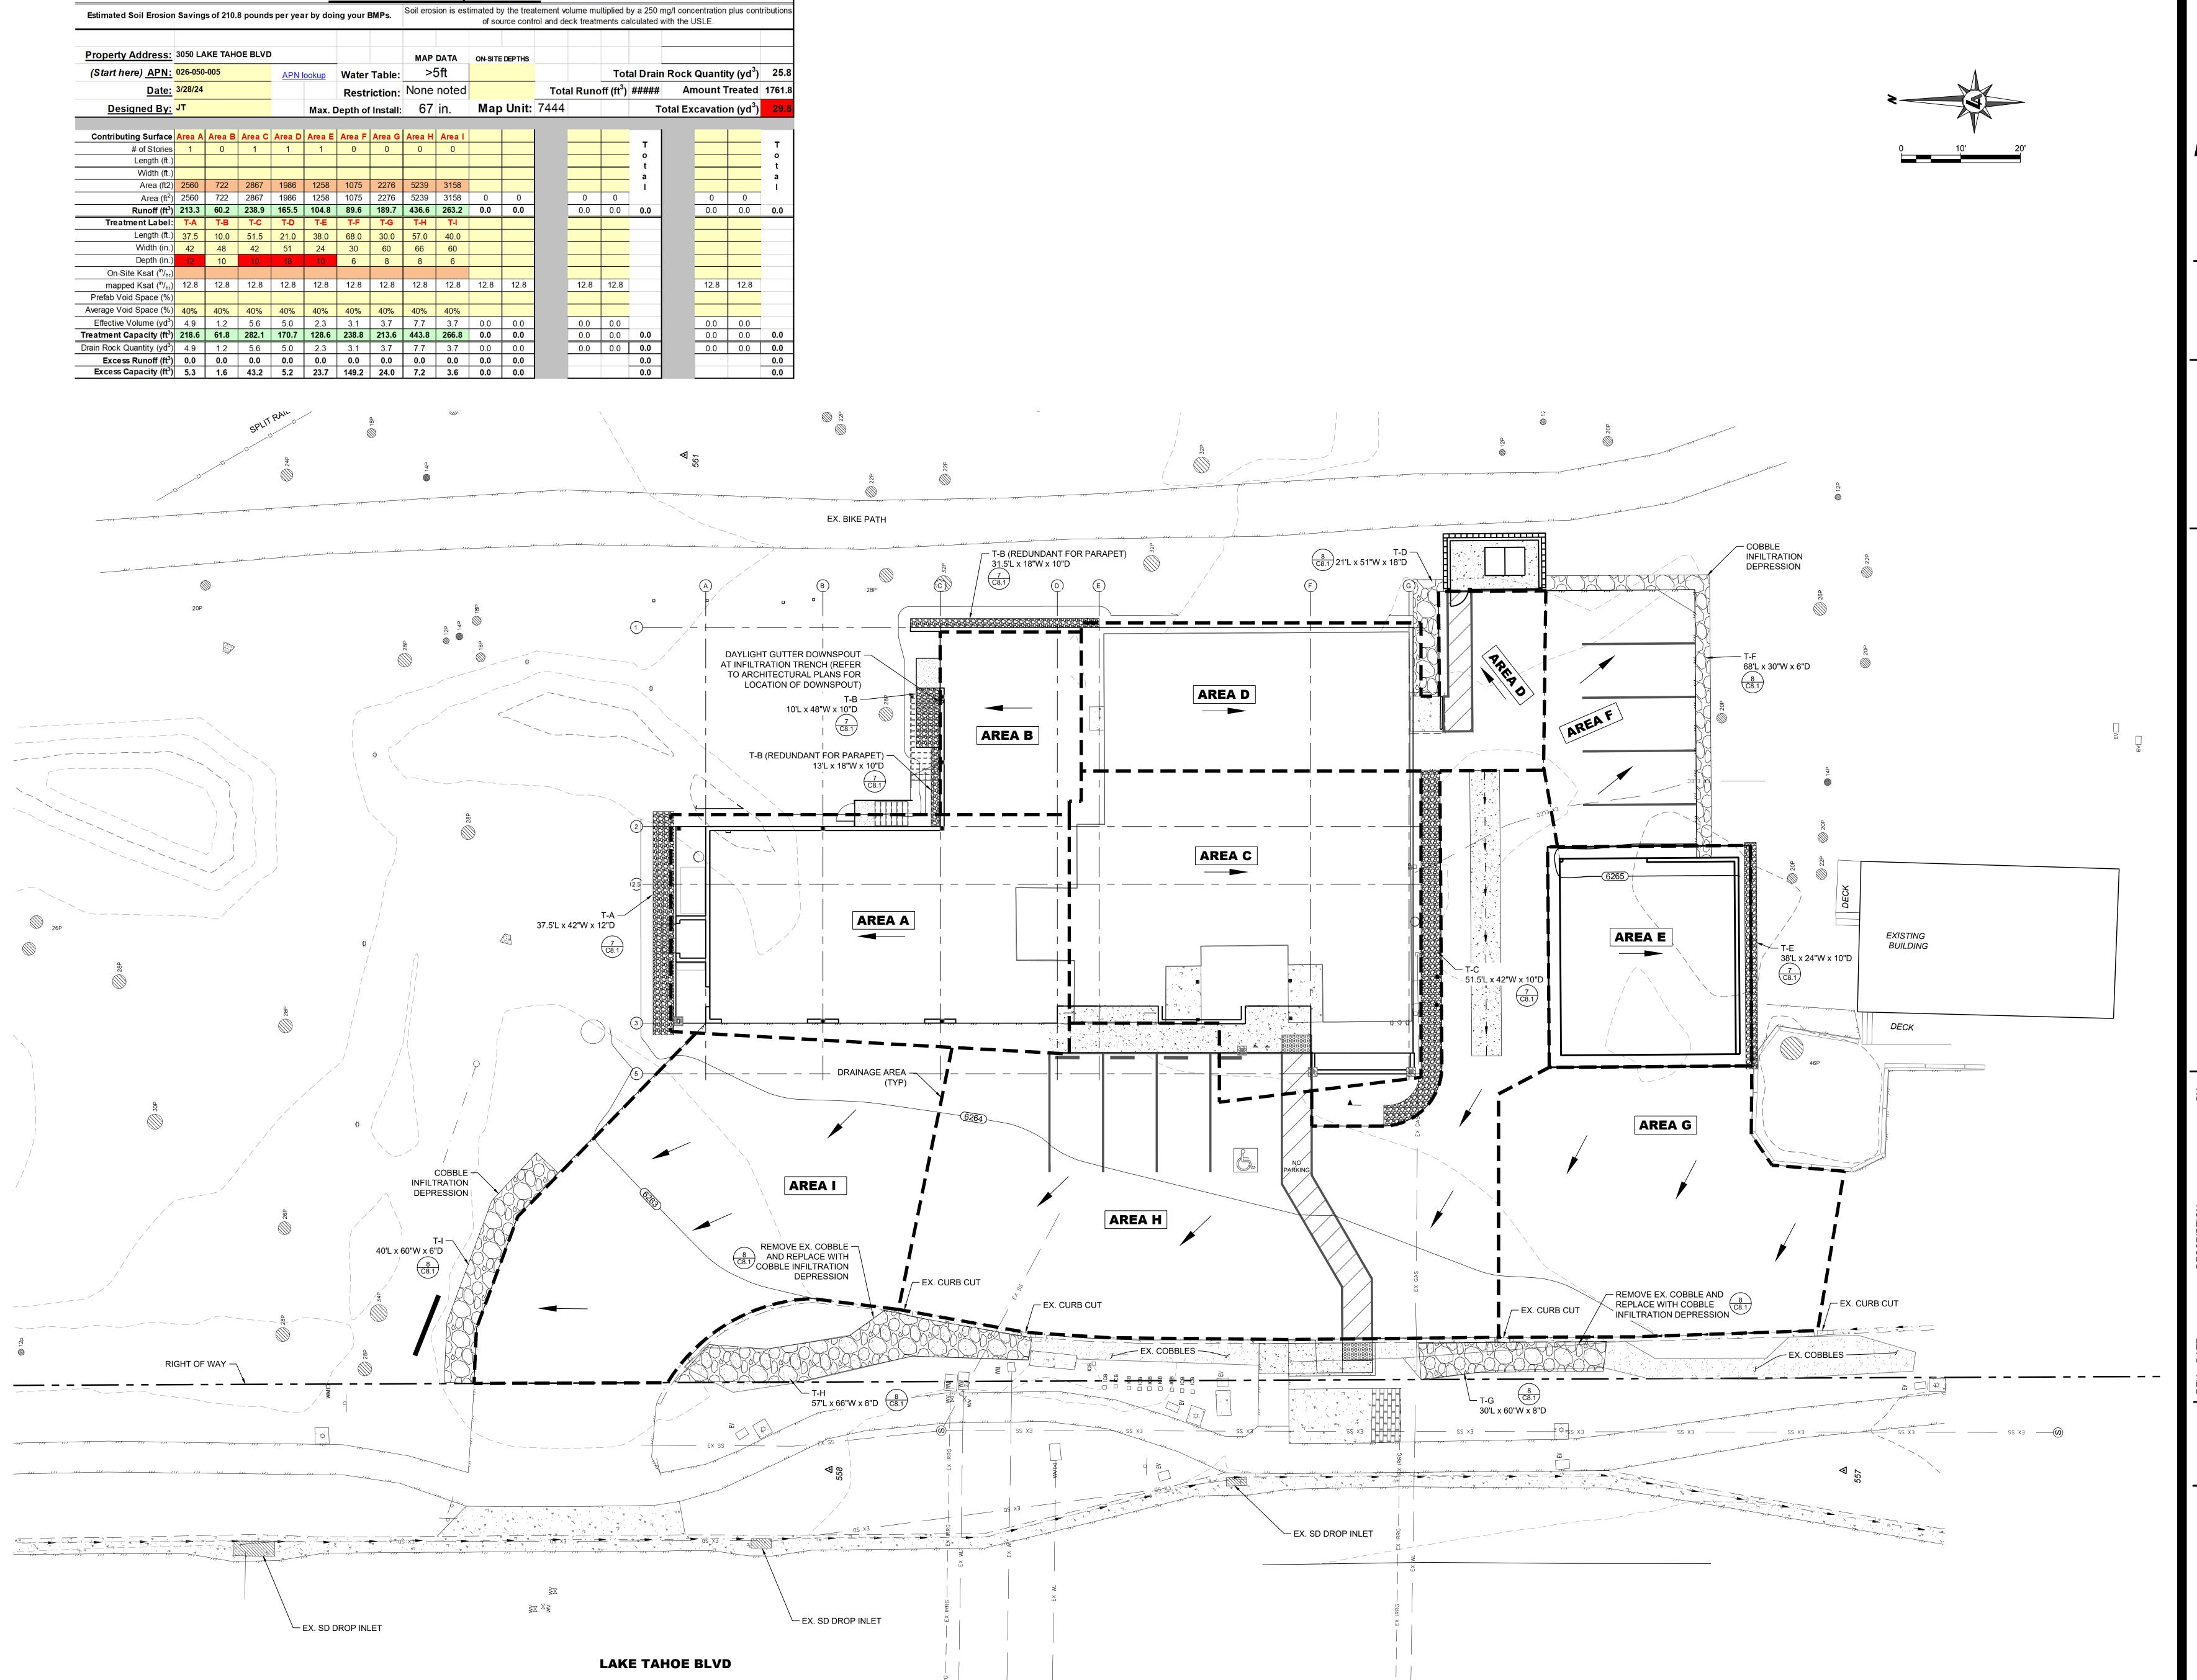


AMBULANCE BUILDING ACK PARKING LOT IMPF

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BMP Calculation Spreadsheet

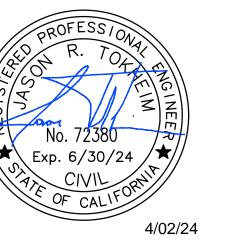

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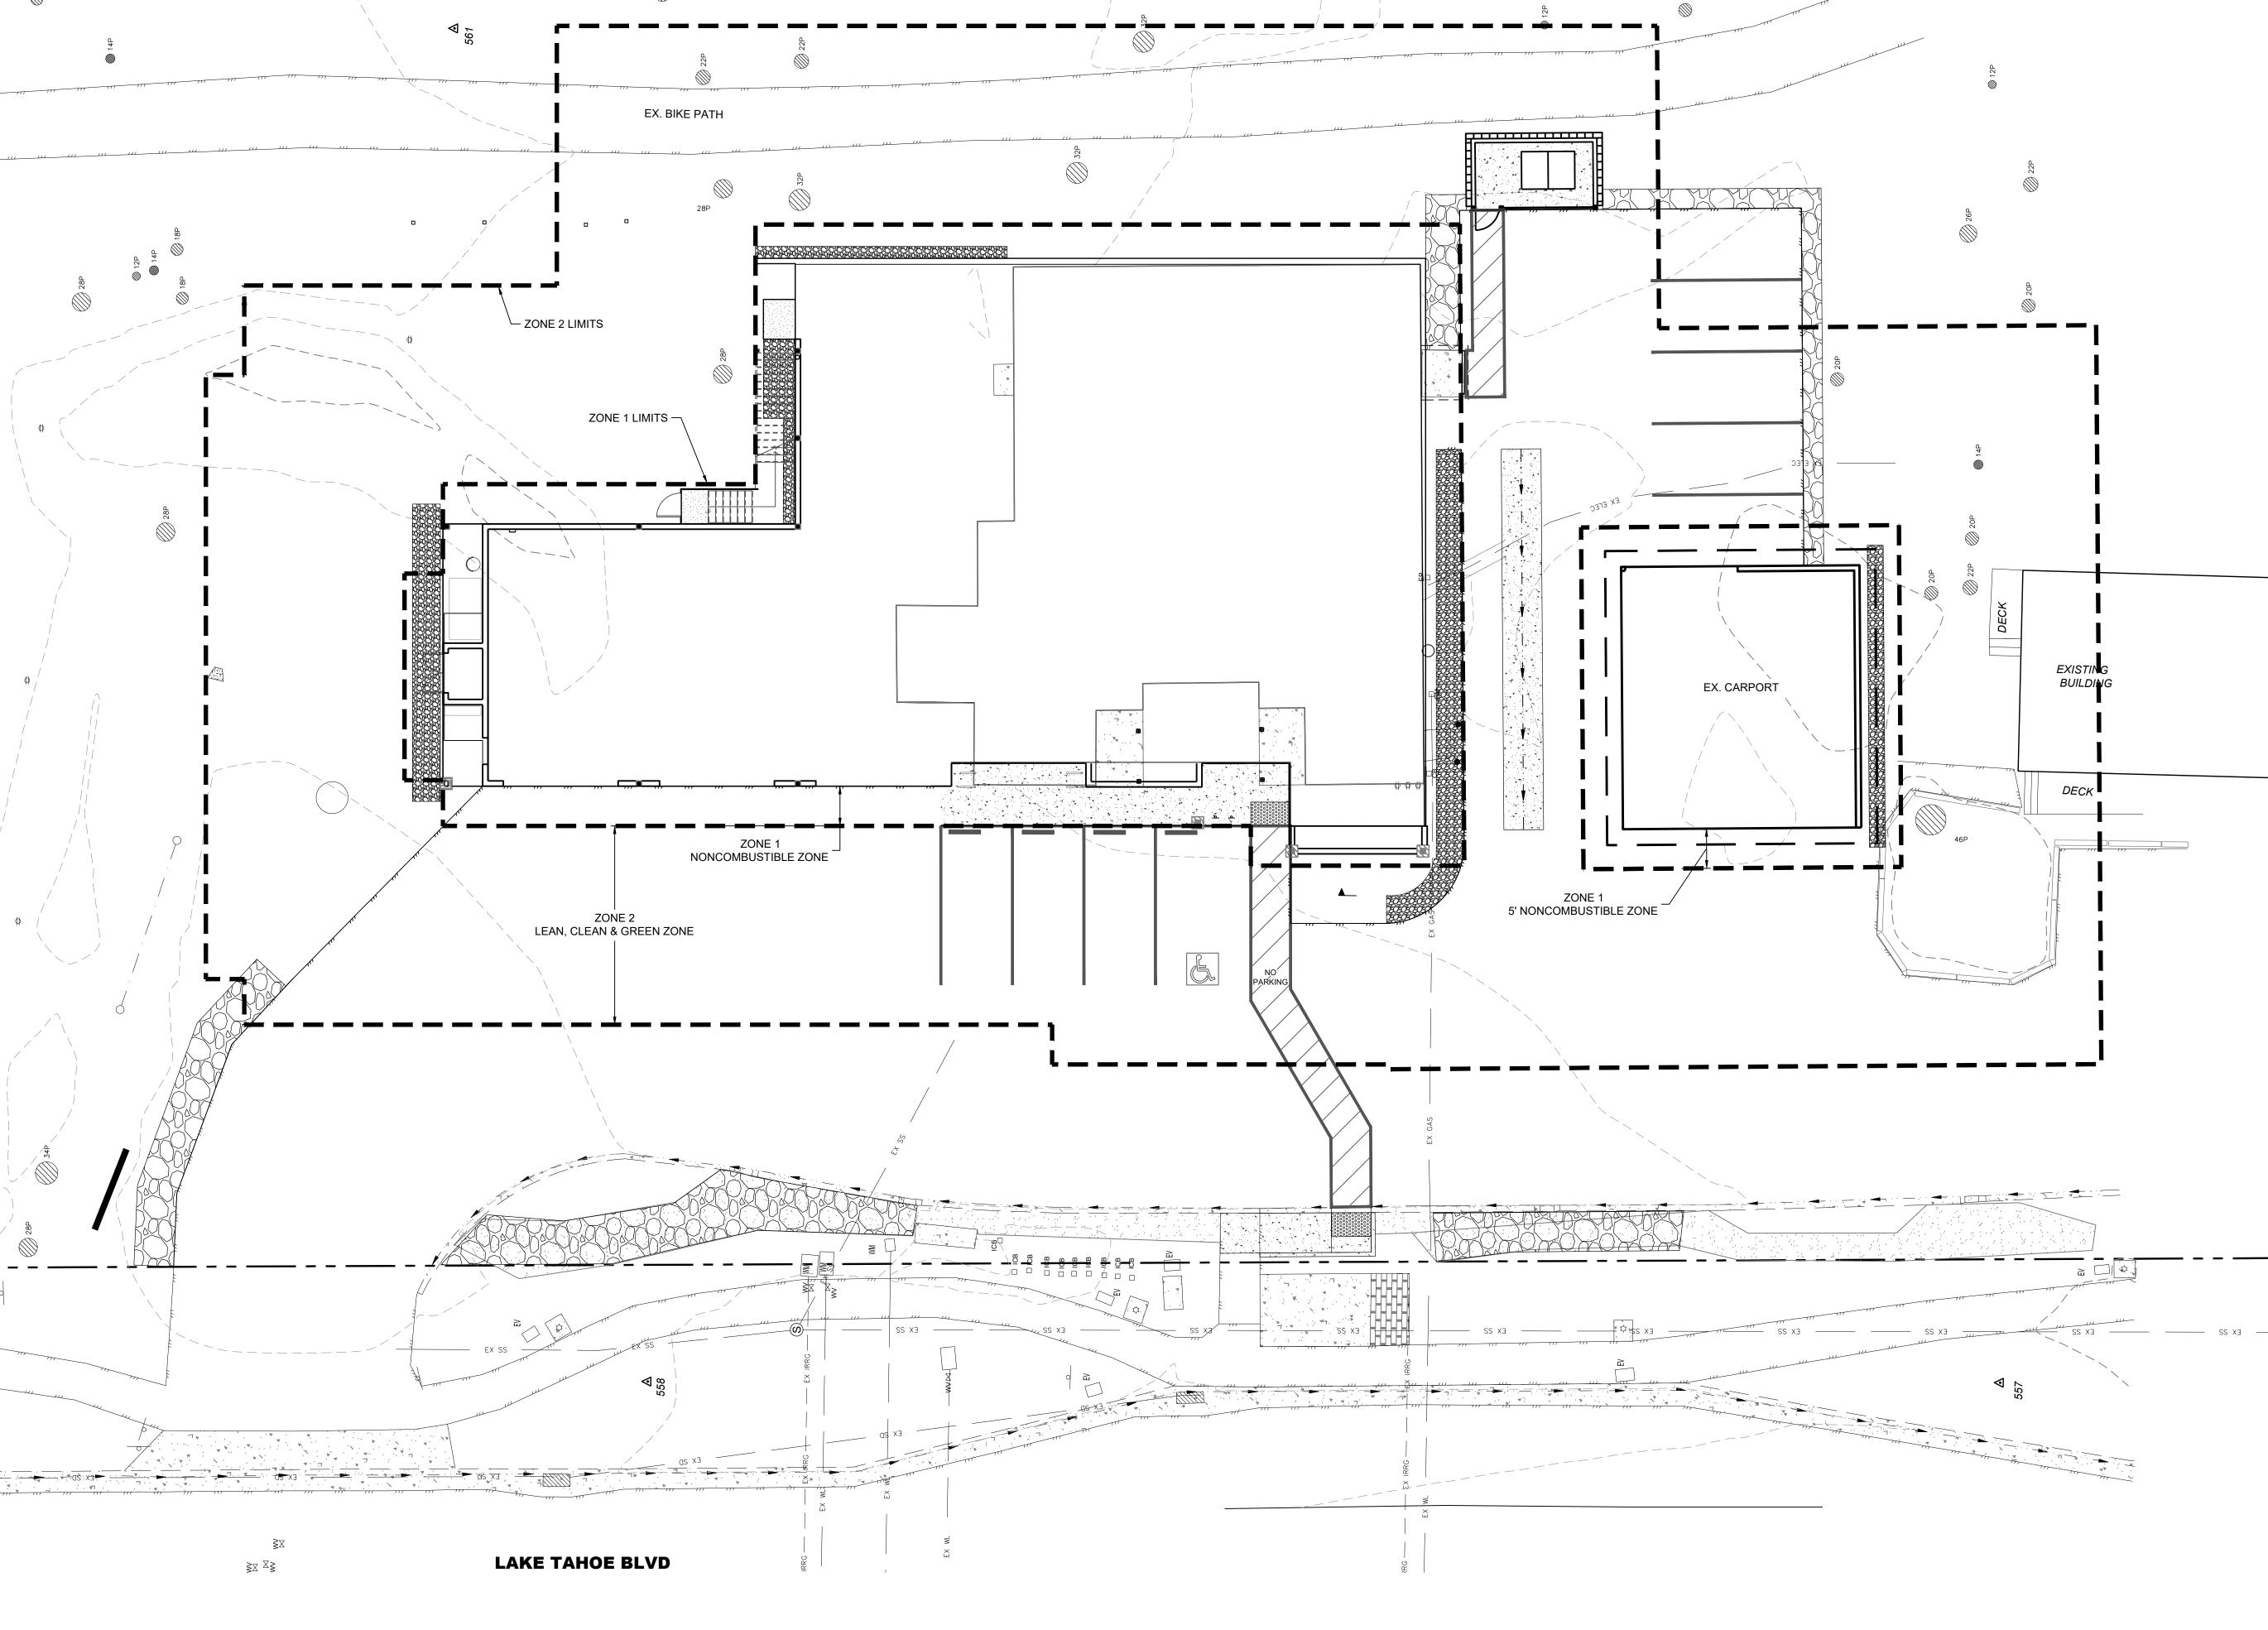



AMBUL

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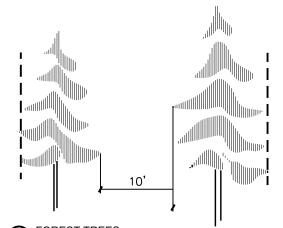
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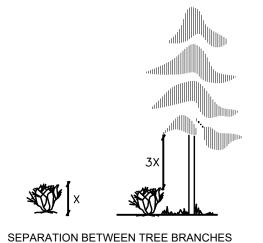
SAGEBRUSH, MANZANITA, HUCKLEBERRY OAK, AND OTHER SHRUBS: ON FLAT TO GENTLY SLOPING TERRAIN, INDIVIDUAL SHRUBS OR SMALL CLUMPS OF SHRUBS WITHIN THE DEFENSIBLE SPACE ZONE SHOULD BE SEPARATED FROM ONE ANOTHER BY AT LEAST TWICE THE HEGIHT OF THE AVERAGE SHRUB. FOR HOMES LOCATED ON STEEPER SLOPES, THE SEPARATION DISTANCE SHOULD BE

FOR EXAMPLE, IF THE TYPICAL SHRUB HEIGHT IS 2 FEET, THEN THERE SHOULD BE A SEPARATION BETWEEN SHRUB BRANCHES OF AT LEAST 4 FEET. REMOVE SHRUBS OR PRUNE TO REDUCE THEIR HEIGHT AND/OR DIAMETER.



WESTERN JUNIPER IF POSSIBLE.

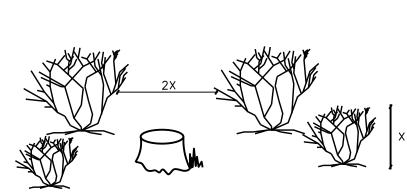ON FLAT OR GENTLY SLOPING TERRAIN, TREES SHOULD BE THINNED TO PROVIDE AN AVERAGE SEPARATION BETWEEN THE CANOPIES OF AT LEAST 10 FEET (TRPA). FOR HOMES LOCATED ON STEEPER SLOPES, THE SEPARATION DISTANCE SHOULD BE GREATER. STUMPS SHOULD BE CUT FLUSH TO THE GROUND FOR TREES LESS THAN 6 INCHES IN DIAMETER AT BREAST HEIGHT, AND TO WITHIN 6 INCHES OF THE GROUND FOR LARGER TREES. THE STUMPS CUT SURFACE SHOULD BE COATED WITH POWDERED BORAX TO RETARD THE SPREAD OF ROOT DISEASES. WHEN SELECTING TREES FOR REMOVAL, CONSIDER CUTTING UNHEALTHY, DAMAGED, OR WEAK TREES. RETAIN LESS COMMON SPECIES OF TREES, SUCH AS INCENSE CEDAR, SUGAR PINE, AND




PLANTS BELOW THE TREE.

& LOWER GROWING PLANTS

IF TREES ARE PRESENT WITHIN THE DEFENSIBLE SPACE ZONE, THERE SHOULD BE A SEPARATION BETWEEN THE LOWER GROWING VEGETATION AND THE LOWEST TREE BRANCHES. VEGETATION THAT CAN CARRY FIRE BURNING IN LOW GROWING PLANTS TO TALLER PLANTS IS CALLED "LADDER FUEL." FOR LARGE TREES. THE RECOMMENDED SEPARATION FOR LADDER FUELS IS THREE TIMES THE HEIGHT OF THE LOWER VEGETATION LAYER. PRUNE BRANCHES FROM LOWER THIRD OF THE TREE HEIGHT, SHORTEN THE HEIGHT OF THE SHRUBS, OR REMOVE PLANTS. DO NOT REMOVE MORE THAN ONE-THIRD OF THE TOTAL TREE BRANCHES. WHEN THERE IS NO UNDERSTORY VEGETATION PRESENT, REMOVE LOWER TREE BRANCHES TO A HEIGHT OF AT LEAST FIVE FEET ABOVE GROUND. DURING FIRE, THIS WILL HELP PREVENT BURNING NEEDLES AND TWIGS THAT ARE LYING ON THE GROUND FROM IGNITING THE TREE. FOR SHORTER TREES, WHERE THREE TIMES THE HEIGHT OF THE LOWER VEGETATION LAYER EXTENDS BEYOND THE LOWER THIRD OF

THE TREE HEIGHT, SHORTEN THE HEIGHT OF THE SHRUBS OR REMOVE

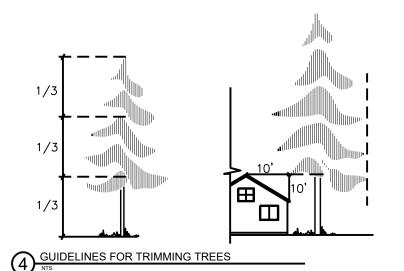

ALL RESIDUAL TREES WILL BE LIMBED TO A HEIGHT OF 10'-0" FEET FROM GROUND, NOT TO EXCEED 1/3 OF THE TOTAL TREE HEIGHT.

ALL RESIDUAL TREES WILL BE LIMBED TO ACHIEVE (10) FEET OF CLEARANCE FROM ANY PART OF THE HOUSE TO THE BRANCHES OF THE TREE. IF THIS WOULD REQUIRE REMOVAL OF THE CROWN EXCEEDING THE LOWER 1/3 OF THE TREE, THEN THE ENTIRE SHEET SHOULD BE REMOVED.

TRIM ALL LOW HANGING LIMBS SO THAT NONE ARE LOWER THAN 10'-0" OF THE

ZONE 1: 0-5' NONCOMBUSTIBLE AREA

CREATE A NONCOMBUSTIBLE AREA AT LEAST 5 FEET WIDE AROUND THE BASE OF THE STRUCTURE (INCLUDING ALL DECKS). THIS AREA NEEDS TO HAVE A VERY LOW POTENTIAL FOR IGNITION FROM FLYING EMBERS. USE IRRIGATED HERBACEOUS PLANTS SUCH AS LAWN, GROUND COVER, AND FLOWERS THAT ARE RECOMMENDED FOR THE LAKE TAHOE BASIN; ROCK MULCHES; OR HARD SURFACES, SUCH AS BRICK AND PAVERS, IN THIS

1. THE AREA WITHIN 0-5' OF THE FOUNDATION OR SUPPORT POSTS SHOULD CONTAIN NO COMBUSTIBLE MATERIALS, INCLUDING COMBUSTIBLE PLANT MATERIAL. A 3" GRAVEL MOAT IS THE PREFERRED MATERIAL OF USE. DRIP LINES MAY BE INCORPORATED INTO THIS

2. REMOVE ALL PINE NEEDLES AND FOREST DUFF WITHIN THIS AREA.

ZONE 2: 5-30' LEAN, CLEAN AND GREEN AREA

FOR A DISTANCE OF 5 FEET TO 30 FEET FROM THE STRUCTURE, THERE SHOULD BE A LEAN, CLEAN, AND GREEN AREA. "LEAN" INDICATES THAT ONLY A SMALL AMOUNT OF FLAMMABLE VEGETATION, IF ANY, IS PRESENT WITHIN 30 FEET OF THE STRUCTURE. "CLEAN" MEANS THERE IS LITTLE OR NO ACCUMULATION OF DEAD VEGETATION OR FLAMMABLE DEBRIS WITHIN THE AREA DURING FIRE SEASON. "GREEN" IMPLIES THAT PLANTS LOCATED WITHIN THIS AREA ARE KEPT HEALTHY, GREEN AND IRRIGATED DURING FIRE SEASON.

1. TRIM ALL TREES OVER 20 FEET A MINIMUM OF 10 FEET ABOVE ADJACENT GRADE.

LIMBS) 10 FEET ABOVE ADJACENT GRADE.

TREES OF THE TREE GROUP.

TO DETAIL 2.

2. REMOVE ANY TREE 14 INCHES DIAMETER OR LESS (AS INDICATED ON DRAWINGS) TO CREATE A 10 FOOT SPACE BETWEEN ANY ADJACENT TREE CANOPY. REFER

3. REMOVE ACUMULATION OF DEAD VEGETATION FROM TREES (FLAMMABLE DEBRIS, DEAD BRANCHES AND

4. WITHIN 5-30' OF THE STRUCTURE ONLY SINGLE SPECIMENS OF WELL MAINTAINED AND WELL IRRIGATED SHRUBS OR TREES SHOULD BE PRESENT. SUCH MATERIALS SHOULD NOT BE CAPABLE OF READILY TRANSMITTING FIRE TO THE STRUCTURE. COMBUSTABLE MULCHES OR PINE NEEDLES SHOULD NOT BE USED AS GROUND COVER WITHIN THIS ZONE.

5. ALL BRUSH, TREES OR FLAMMABLE MATERIAL WILL BE REMOVED FROM UNDER THE DRIP LINE OF RESIDENTAIL

6. REMOVE ALL PINE NEEDLES AND FOREST DUFF WITHIN

ZONE 3: 30-100' WILDLAND FUEL REDUCTION AREA

THE WILDLAND FUEL REDUCTION AREA LIES BEYOND THE LEAN, GREEN AREA AND OFTEN CONSISTS OF NATURALLY OCCURING PLANTS (PINE TREES, MANZANITA, SAGEBRUSH, ETC.) WITHIN THIS AREA. REMOVE DEAD VEGETATION, INCLUDING DEAD SHRUBS, DRIED GRASS, FALLEN BRANCHES, THICK ACCUMULATION OF NEEDLES AND LEAVES ETC. THIN, DENSE STANDS OF SHRUBS AND TREES TO CREATE A SEPARATION BETWEEN THEM. REMOVING TREES MORE THAN 14" IN DIAMETER REQUIRES A PERMIT FROM THE TAHOE REGIONAL PLANNING AGENCY (TRPA) OR YOUR LOCAL FIRE PROFESSIONAL.

1. TREE CANOPIES WILL BE SPACED AT LEAST 10 FEET APART. IF TREES ARE GROUPED CLOSE ENOUGH TOGETHER AS TO ACT AS ONE UNIT, THEN ALL OTHER REQUIREMENTS MUST BE MET. REFER TO DETAIL 2.

2. BEYOND 30 FEET FROM THE STRUCTURE, BRUSH FIELDS MUST BE SPACED TO A DISTANCE EQUAL OR GREATER THAN TWO (2) TIMES THE HEIGHT OF THE BRUSH. INDIVIDUAL BRUSH PLANTS WILL NOT EXCEED 100 SQUARE FEET. REFER TO DETAIL 1.

3. PINE NEEDLES ARE ACCEPTABLE WITHIN ZONE 3 AS LONG AS THEY ARE NO THICKER THAN 2 OR 3 INCHES.

FOR SLOPED PROPERTIES, USE THE FOLLOWING STANDARDS FOR

THE ABOVE REQUIREMENTS:

TREES SLOPE SPACING 0-20% 10 FEET BETWEEN EDGES OF CROWNS 20-40% 20 FEET BETWEEN EDGES OF CROWNS

40%-UP 30 FEET BETWEEN EDGES OF CROWNS BRUSH SLOPE SPACING 0-20% 2 X HEIGHT OF RESIDUAL BRUSH

FOR ASSISTANCE.

20-40% 4 X HEIGHT OF RESIDUAL BRUSH

40%-UP 6 X HEIGHT OF RESIDUAL BRUSH

IF THERE IS A NEED TO REMOVE ADDITIONAL TREES NOT INDICATED ON THIS PLAN, THE CONTRACTOR IS TO CONTACT TRPA AND THE LOCAL FIRE MARSHAL



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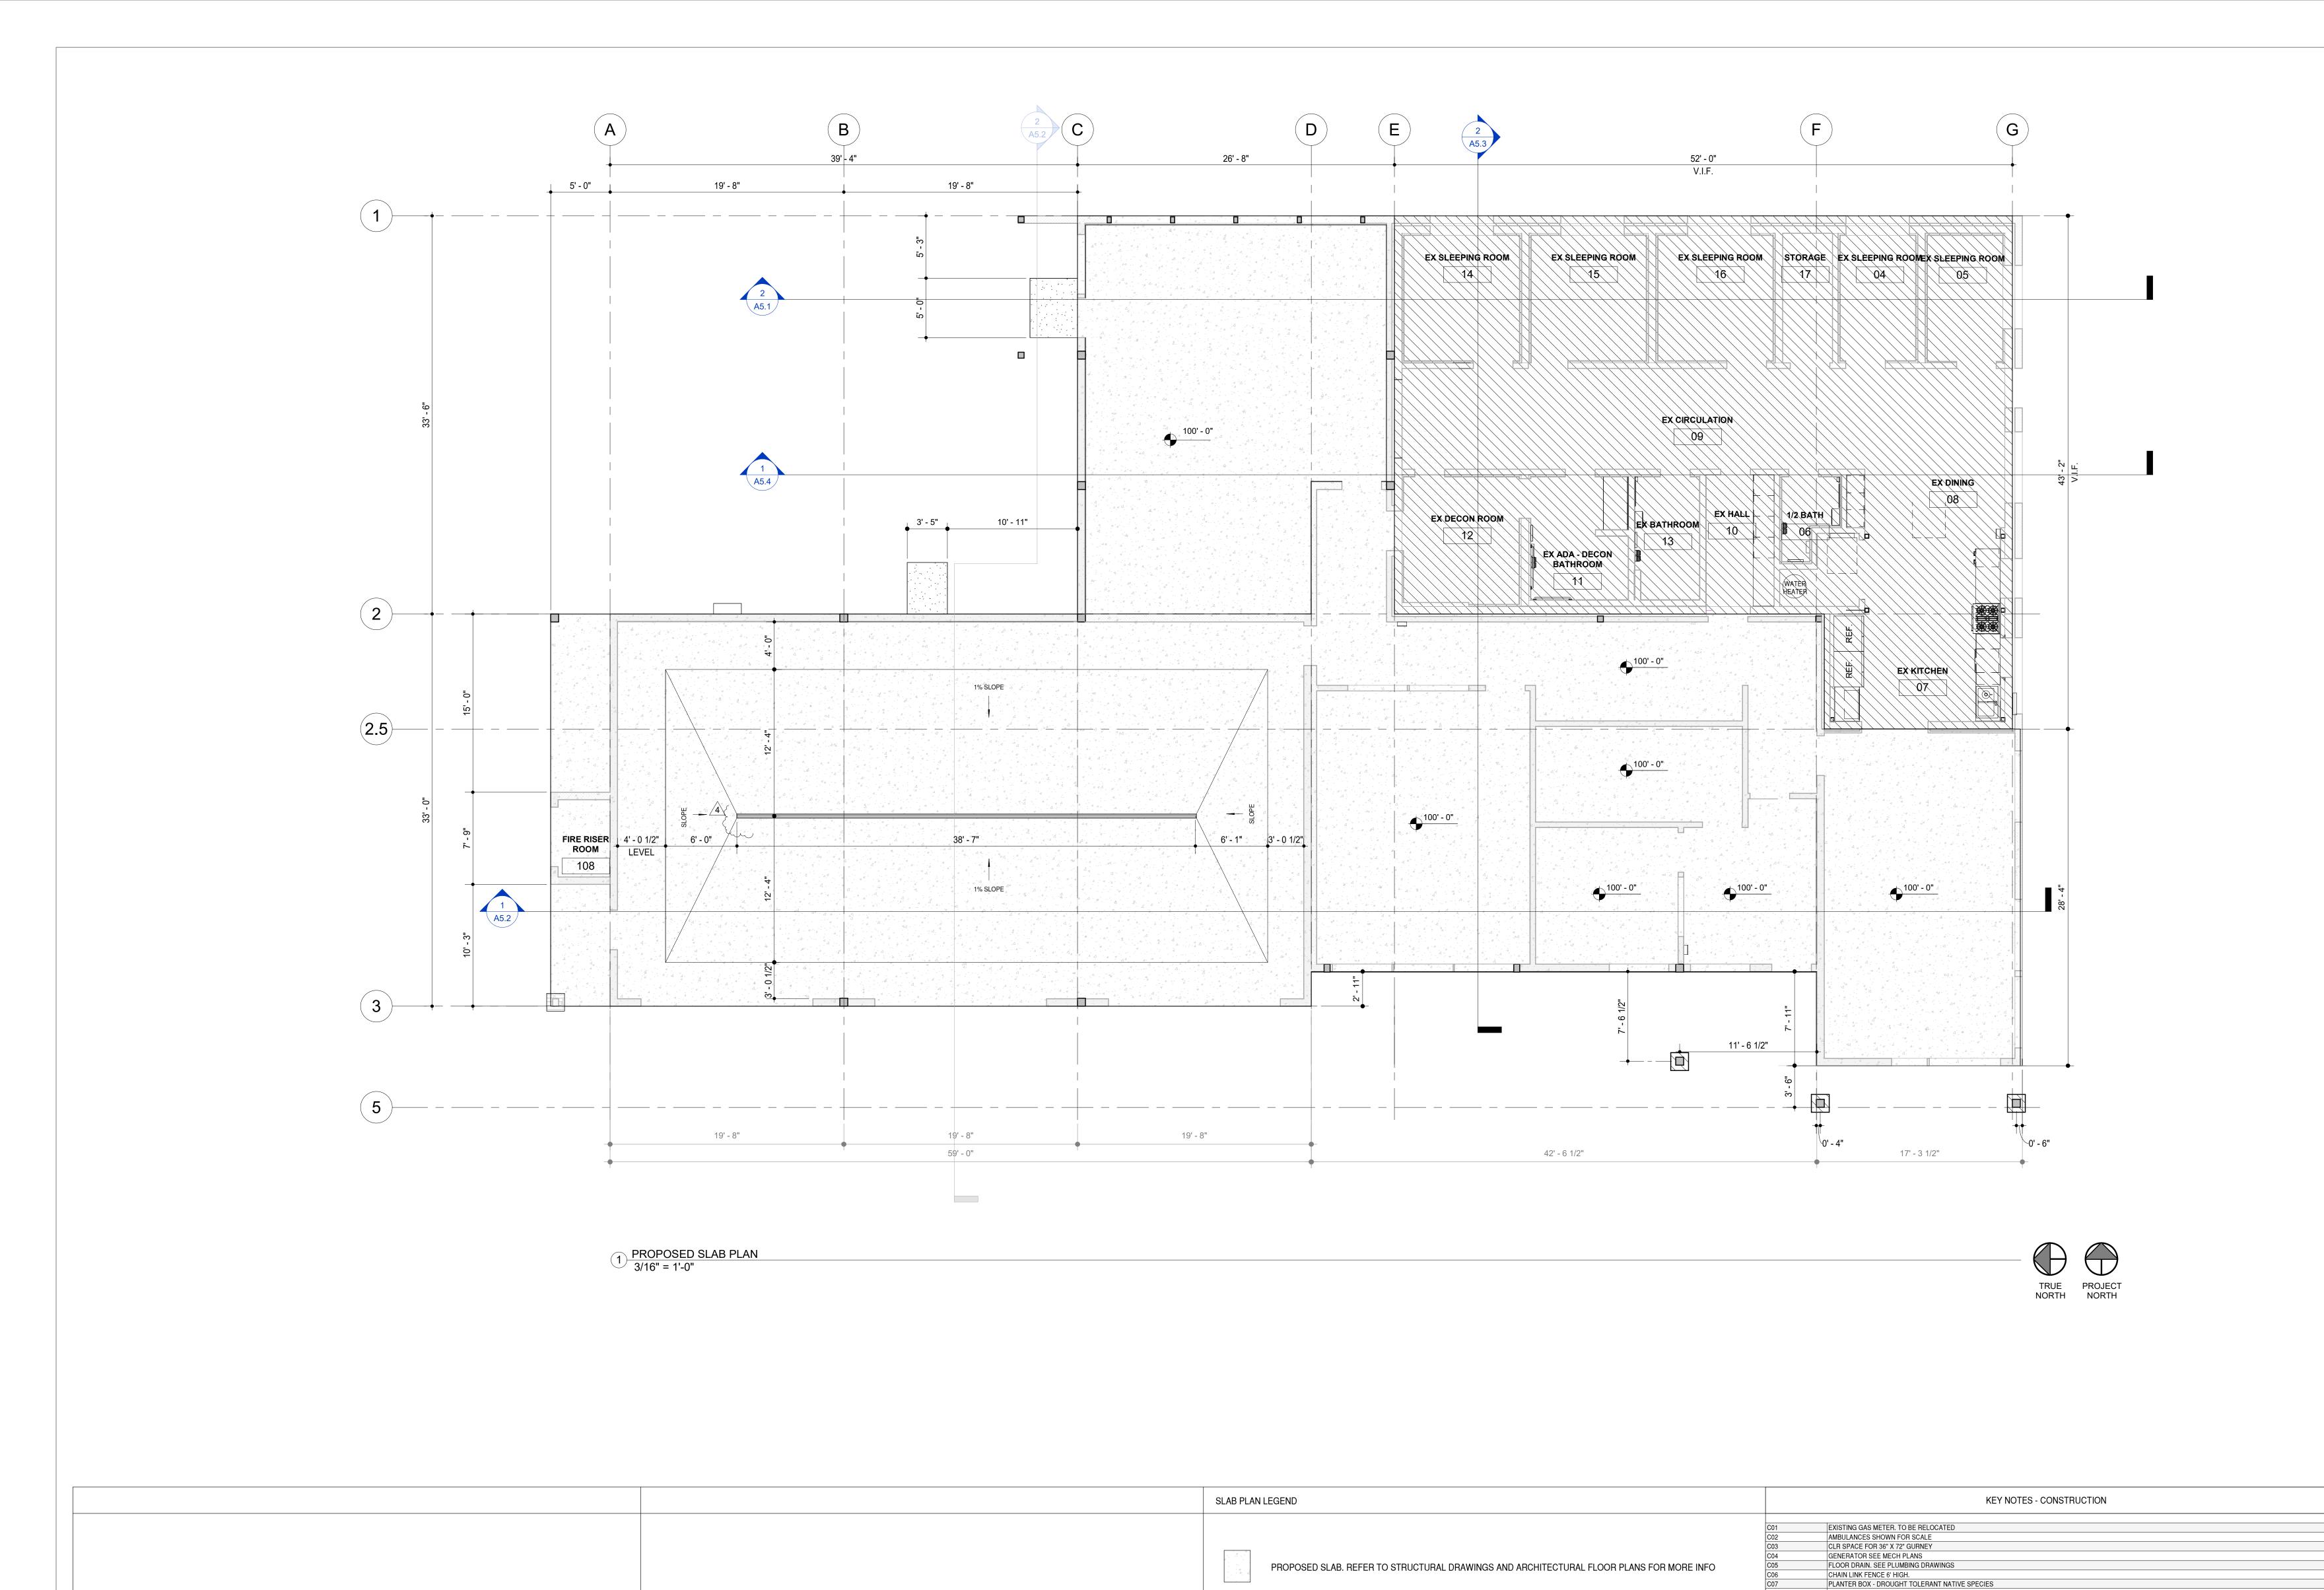
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EXISTING BUILDING NOT IN SCOPE

FINISH FLOOR ELEVATION - COORDINATE WITH EXISTING SLAB FINISH

SLOPE SLABS TO DRAINS

Drawn By BM Project Number 211008 04.21.2023 95% CD PHASE
 No.
 Description
 Date

 1
 TRPA_BID_SUBMITTAL
 04.21.23

 2
 BID SET II
 07.07.23

 3
 ELDO COUNTY BUILDING
 02.20.24
 DEPT PC1 03.20.24 GC RFI Responses A1.0

LOCKABLE MEDICAL STORAGE CABINETS. SUPPLIED AND INSTALLED BY OWNER

RELOCATE EXISTING CAT 5 TO ROOF AND RELOCATE CONDUIT TO ROOF . REMOVE FROM EXISTING EXTERIOR WALL.
HOSE BID.. SEE PLUMBING DWGS.
PRESSURE WASHER. SEE MEP DRAWINGS
AIRVAC SYSTEM
FUR OUT EXISTING CMU WALL

EXISTING ELEC METER.

RELOCATED GAS METER


LOW SLOPE STANDING SEAM METAL ROOF


PROVIDE SNOW GUARD SYSTEM
RELOCATED ELEC METER


MONARCH


ARCHITECTURE


2264 LAKE TAHOE BLVD. SUITE 13 SOUTH LAKE TAHOE CA. 96150 WWW.LAKETAHOEARCHITECT.COM 530.542.2919

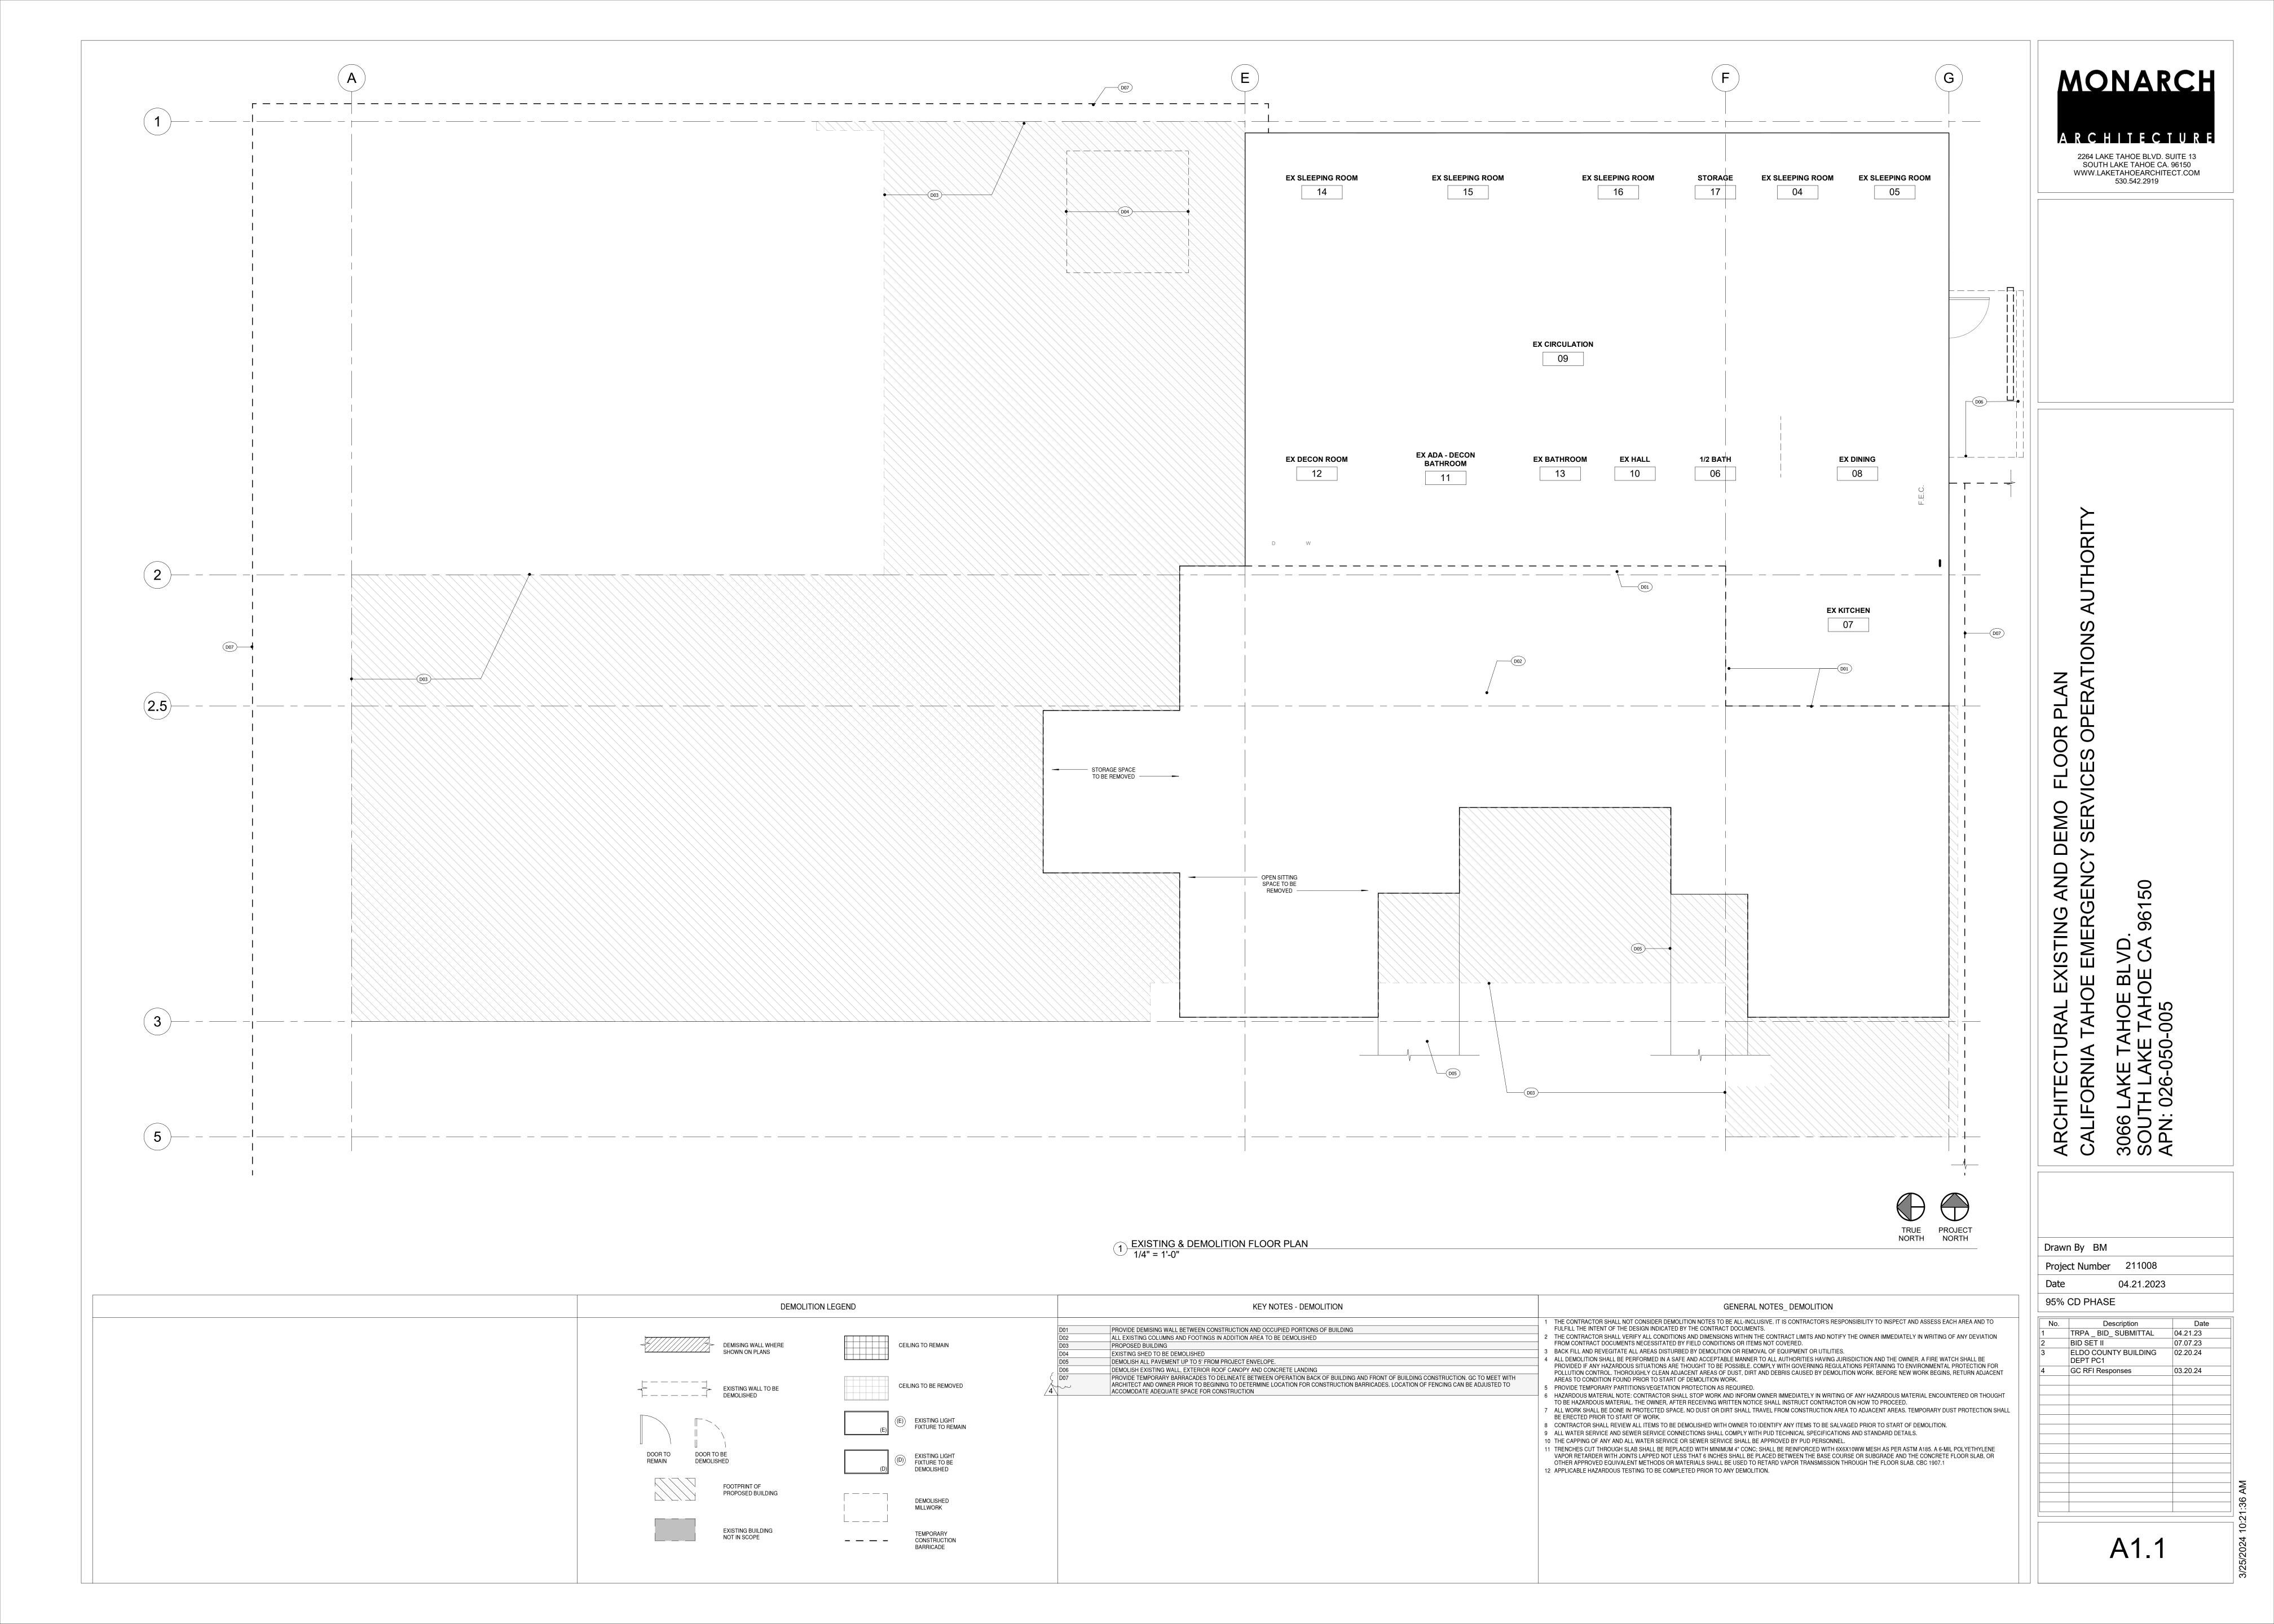

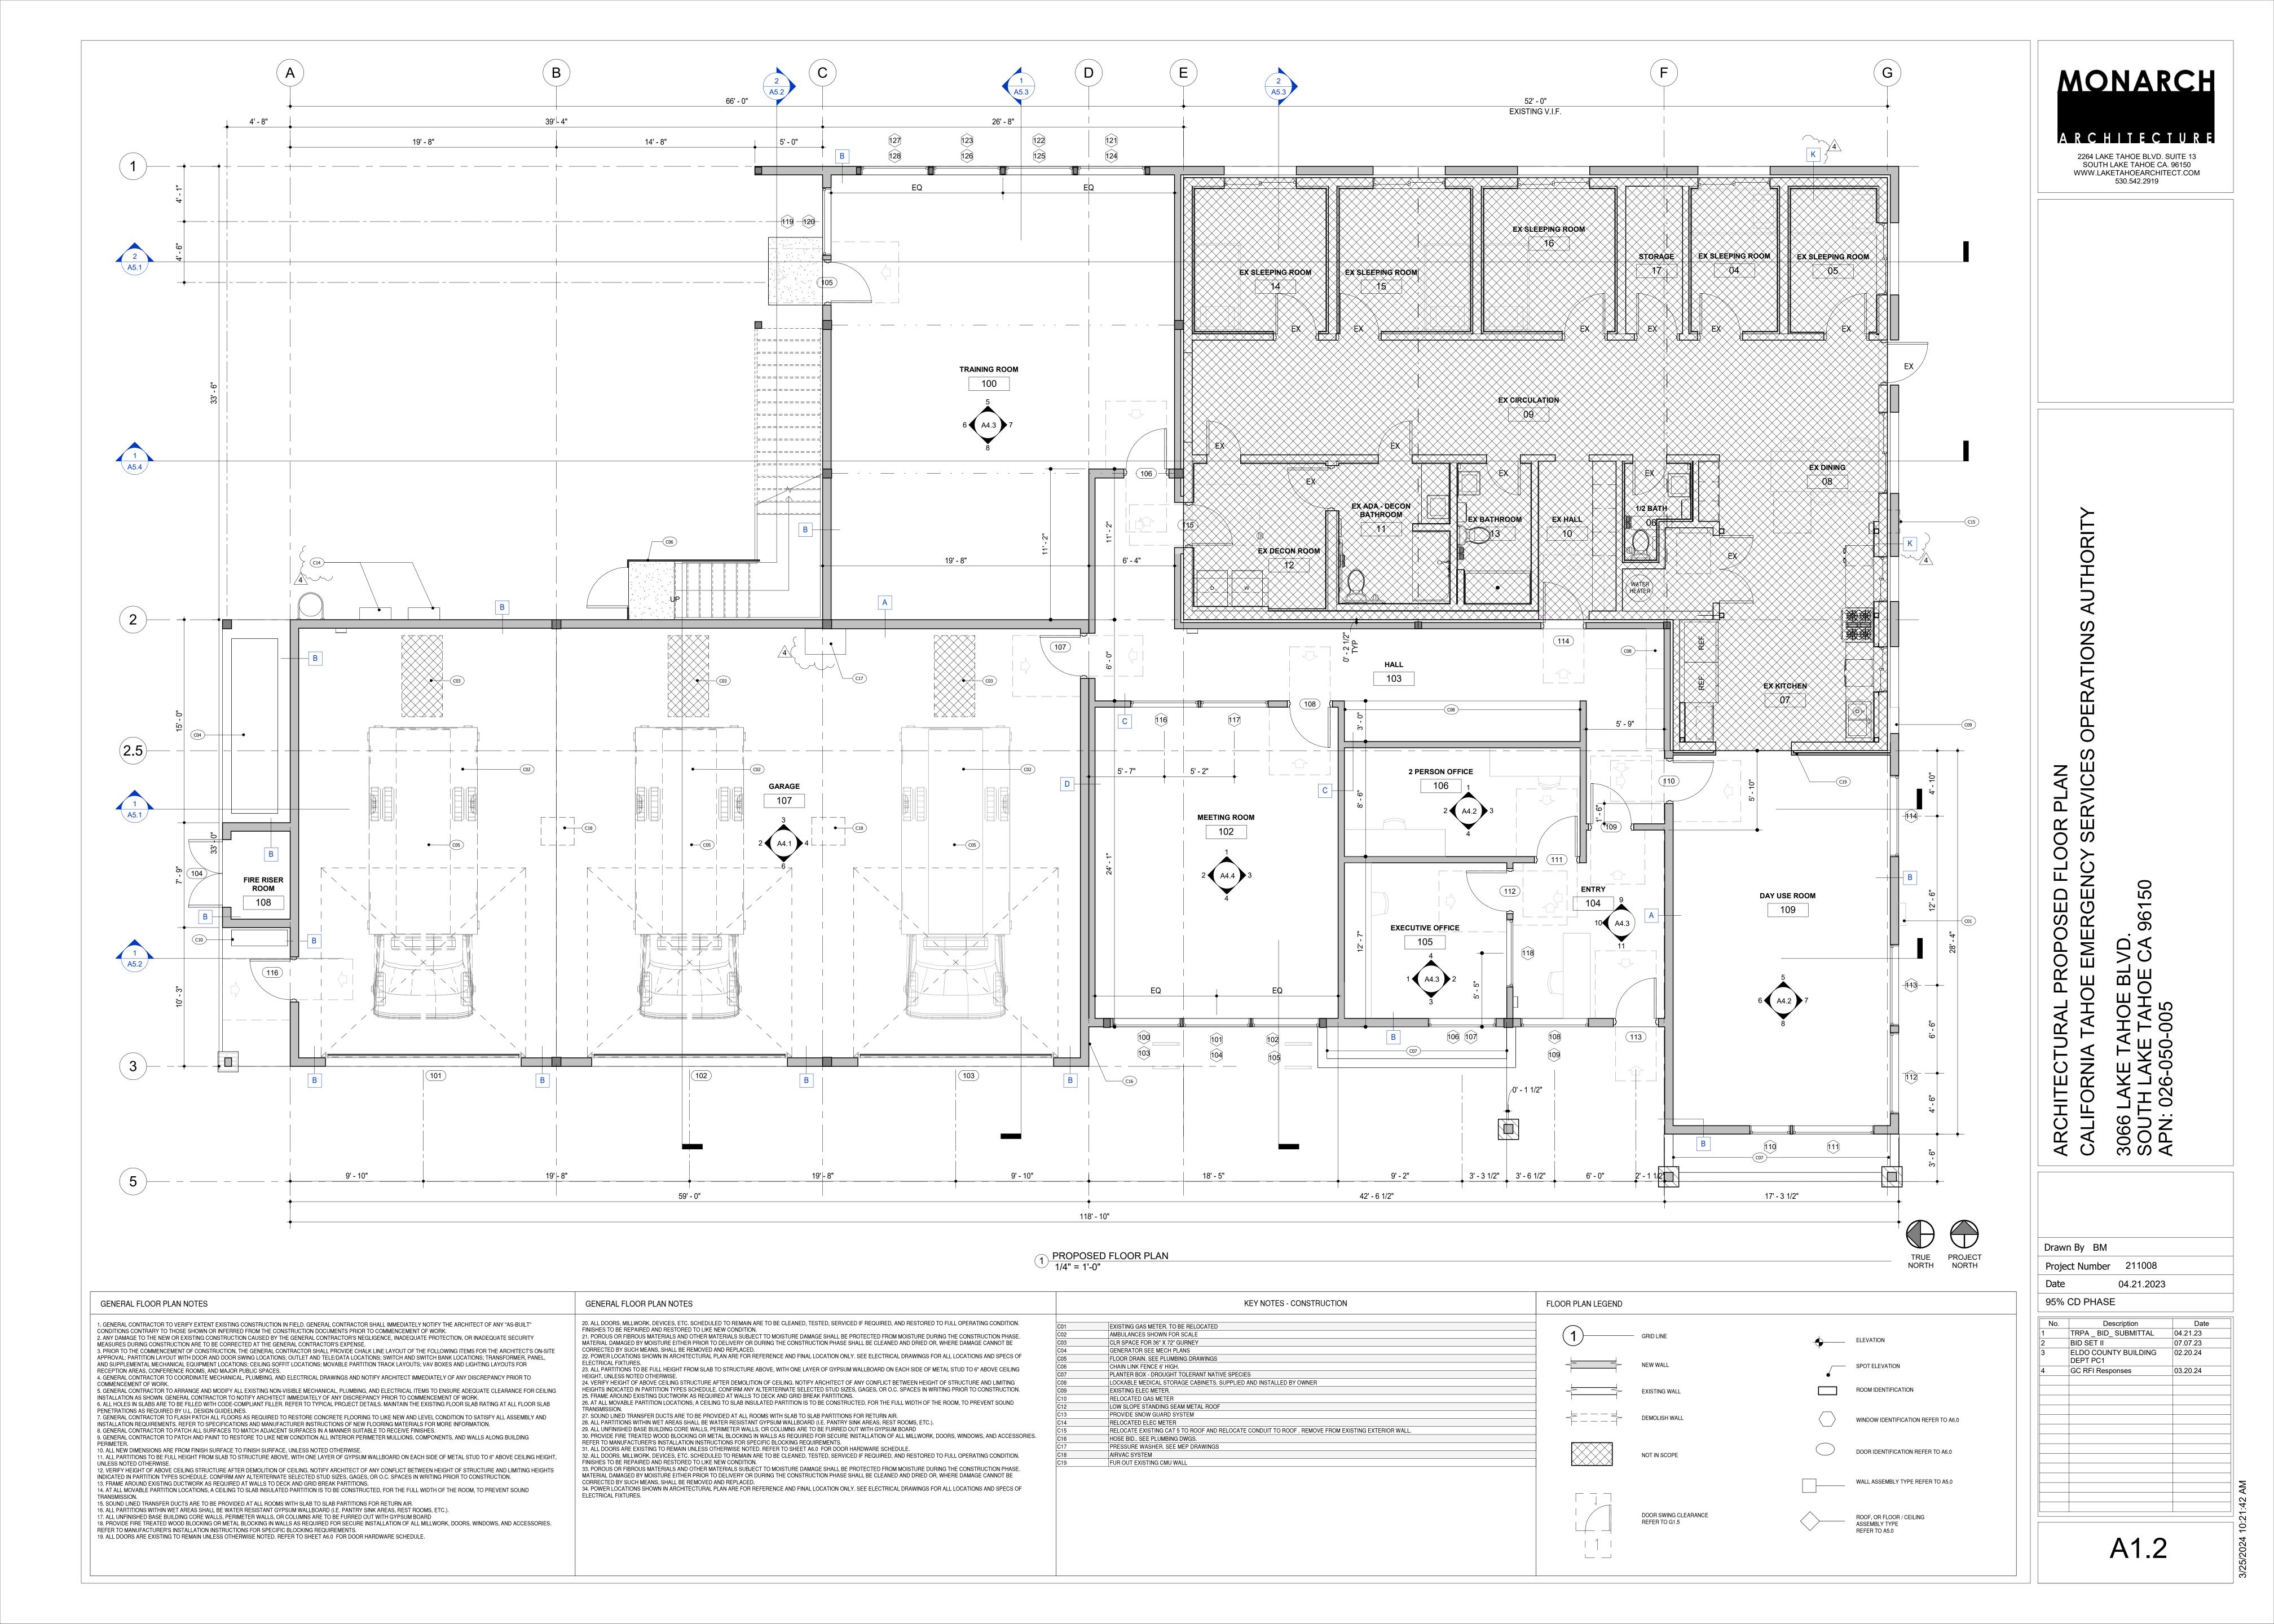

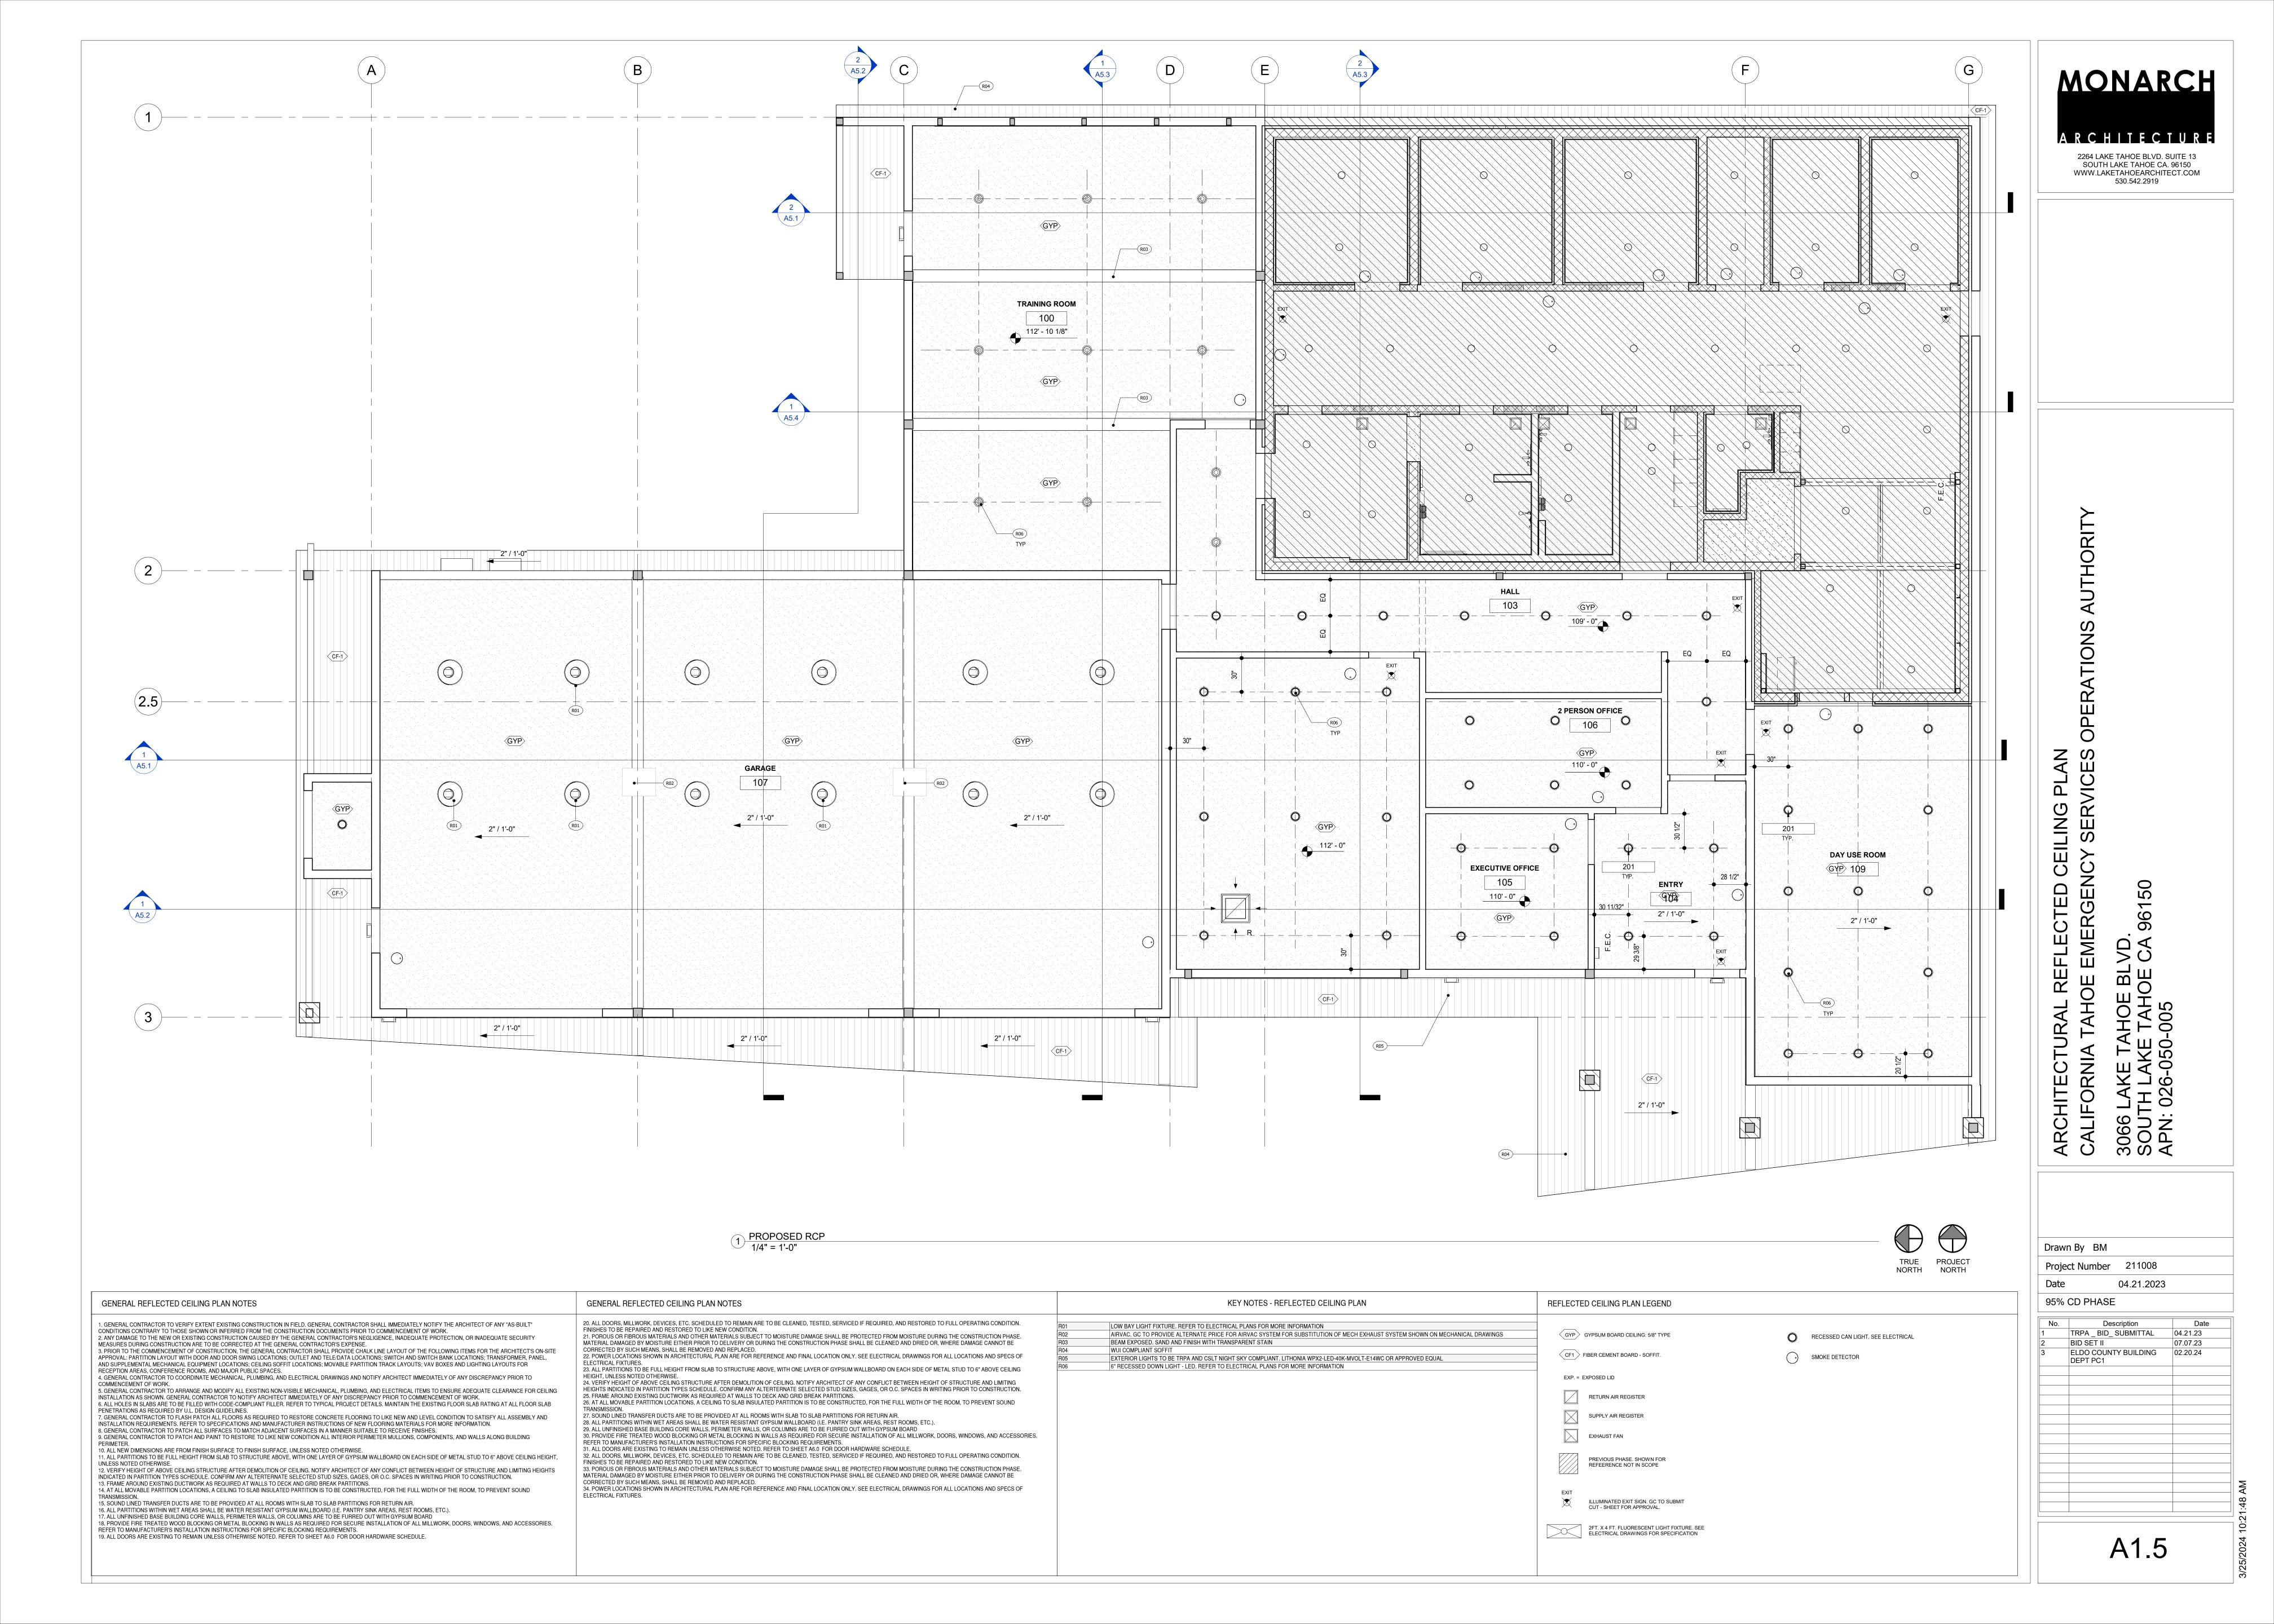

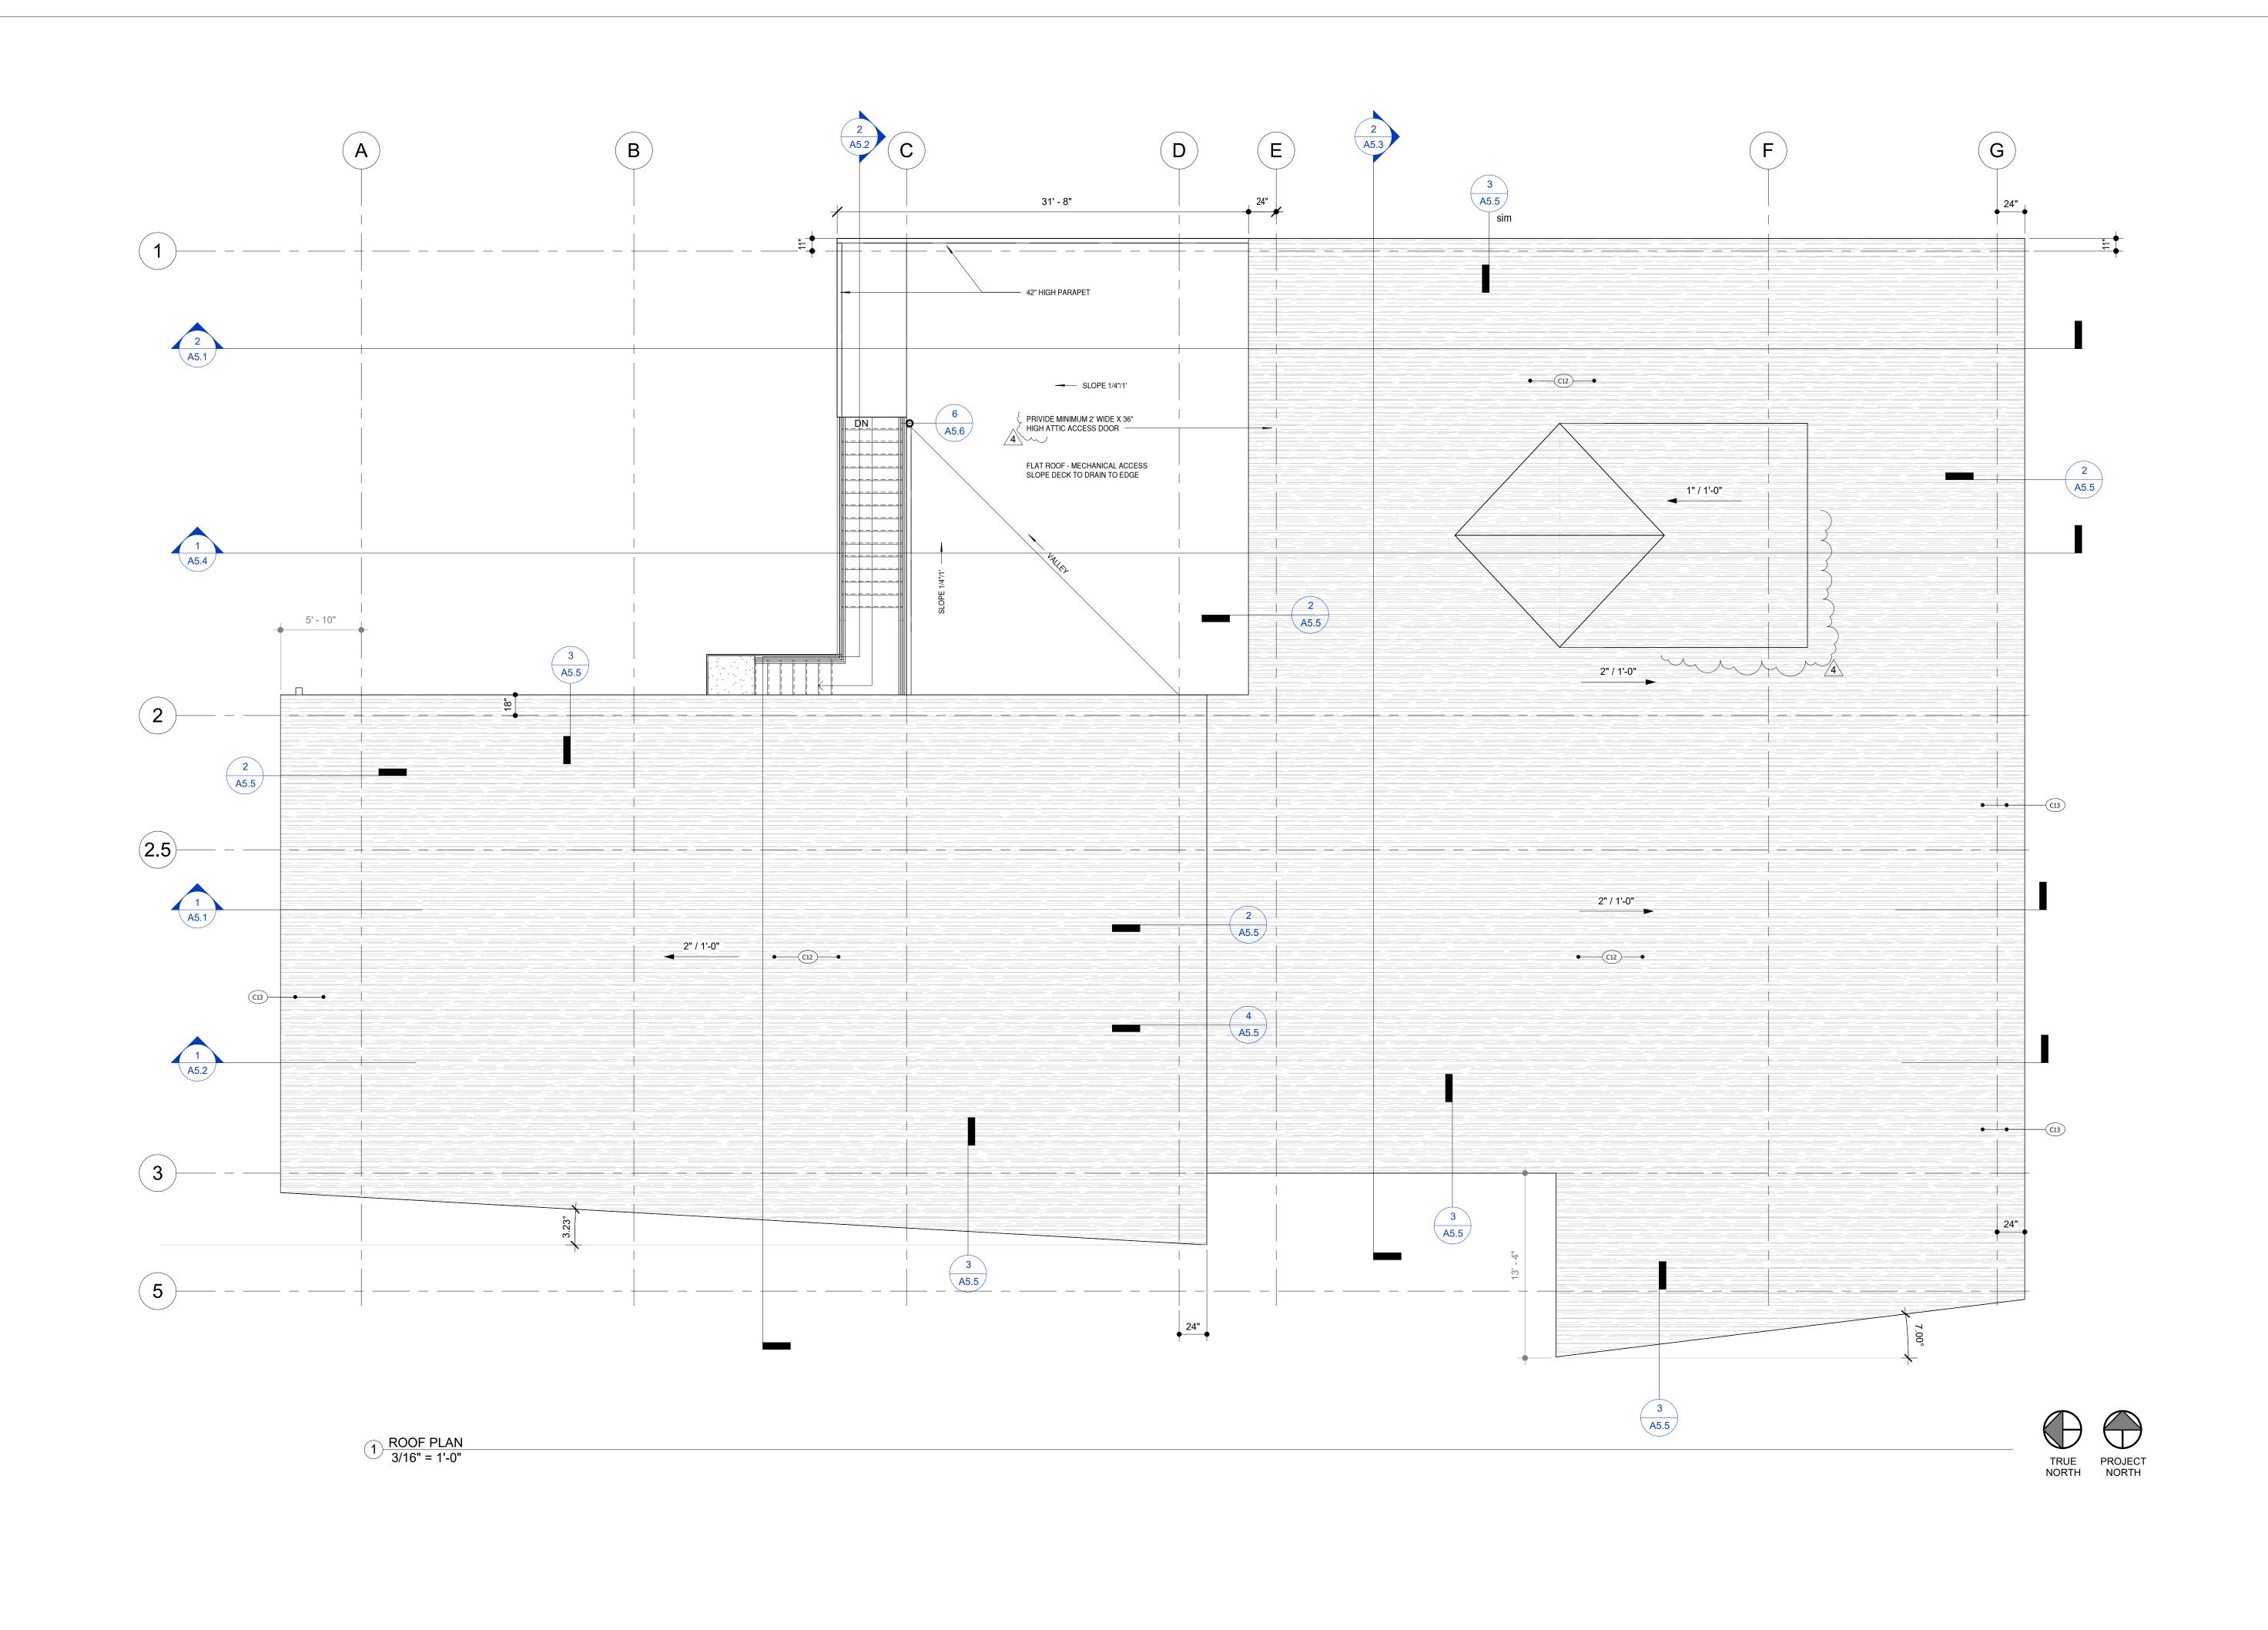

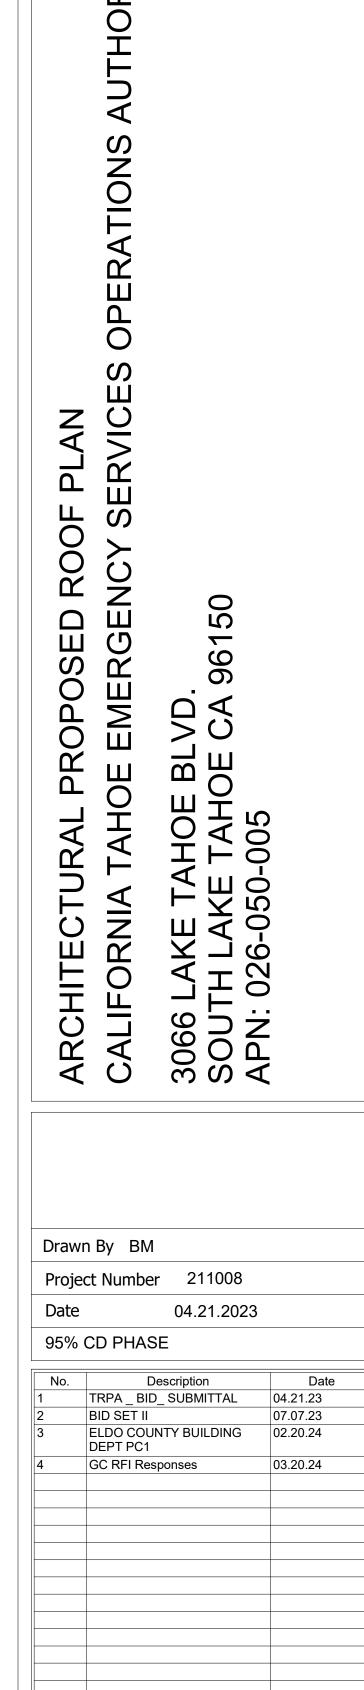

MONARCH

ARCHITECTUR


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GENERAL FLOOR PLAN NOTES GENERAL FLOOR PLAN NOTES **KEY NOTES - CONSTRUCTION** FLOOR PLAN LEGEND 20. ALL DOORS, MILLWORK, DEVICES, ETC. SCHEDULED TO REMAIN ARE TO BE CLEANED, TESTED, SERVICED IF REQUIRED, AND RESTORED TO FULL OPERATING CONDITION. FINISHES TO BE REPAIRED AND RESTORED TO LIKE NEW CONDITION. 1. GENERAL CONTRACTOR TO VERIFY EXTENT EXISTING CONSTRUCTION IN FIELD. GENERAL CONTRACTOR SHALL IMMEDIATELY NOTIFY THE ARCHITECT OF ANY "AS-BUILT" EXISTING GAS METER. TO BE RELOCATED CONDITIONS CONTRARY TO THOSE SHOWN OR INFERRED FROM THE CONSTRUCTION DOCUMENTS PRIOR TO COMMENCEMENT OF WORK. 21. POROUS OR FIBROUS MATERIALS AND OTHER MATERIALS SUBJECT TO MOISTURE DAMAGE SHALL BE PROTECTED FROM MOISTURE DURING THE CONSTRUCTION PHASE.

MATERIAL DAMAGED BY MOISTURE EITHER PRIOR TO DELIVERY OR DURING THE CONSTRUCTION PHASE SHALL BE CLEANED AND DRIED OR, WHERE DAMAGE CANNOT BE AMBULANCES SHOWN FOR SCALE 2. ANY DAMAGE TO THE NEW OR EXISTING CONSTRUCTION CAUSED BY THE GENERAL CONTRACTOR'S NEGLIGENCE, INADEQUATE PROTECTION, OR INADEQUATE SECURITY CLR SPACE FOR 36" X 72" GURNEY MEASURES DURING CONSTRUCTION ARE TO BE CORRECTED AT THE GENERAL CONTRACTOR'S EXPENSE. CORRECTED BY SUCH MEANS, SHALL BE REMOVED AND REPLACED. GENERATOR SEE MECH PLANS 3. PRIOR TO THE COMMENCEMENT OF CONSTRUCTION, THE GENERAL CONTRACTOR SHALL PROVIDE CHALK LINE LAYOUT OF THE FOLLOWING ITEMS FOR THE ARCHITECT'S ON-SITE APPROVAL: PARTITION LAYOUT WITH DOOR AND DOOR SWING LOCATIONS; OUTLET AND TELE/DATA LOCATIONS; SWITCH AND SWITCH BANK LOCATIONS; TRANSFORMER, PANE 2. POWER LOCATIONS SHOWN IN ARCHITECTURAL PLAN ARE FOR REFERENCE AND FINAL LOCATION ONLY. SEE ELECTRICAL DRAWINGS FOR ALL LOCATIONS AND SPECS OF ELECTRICAL FIXTURES. AND SUPPLEMENTAL MECHANICAL EQUIPMENT LOCATIONS; CEILING SOFFIT LOCATIONS; MOVABLE PARTITION TRACK LAYOUTS; VAV BOXES AND LIGHTING LAYOUTS FOR SPOT ELEVATION CHAIN LINK FENCE 6' HIGH. 23. ALL PARTITIONS TO BE FULL HEIGHT FROM SLAB TO STRUCTURE ABOVE, WITH ONE LAYER OF GYPSUM WALLBOARD ON EACH SIDE OF METAL STUD TO 6" ABOVE CEILING RECEPTION AREAS, CONFERENCE ROOMS, AND MAJOR PUBLIC SPACES. PLANTER BOX - DROUGHT TOLERANT NATIVE SPECIES 4. GENERAL CONTRACTOR TO COORDINATE MECHANICAL, PLUMBING, AND ELECTRICAL DRAWINGS AND NOTIFY ARCHITECT IMMEDIATELY OF ANY DISCREPANCY PRIOR TO LOCKABLE MEDICAL STORAGE CABINETS. SUPPLIED AND INSTALLED BY OWNER 24. VERIFY HEIGHT OF ABOVE CEILING STRUCTURE AFTER DEMOLITION OF CEILING. NOTIFY ARCHITECT OF ANY CONFLICT BETWEEN HEIGHT OF STRUCTURE AND LIMITING COMMENCEMENT OF WORK. 5. GENERAL CONTRACTOR TO ARRANGE AND MODIFY ALL EXISTING NON-VISIBLE MECHANICAL, PLUMBING, AND ELECTRICAL ITEMS TO ENSURE ADEQUATE CLEARANCE FOR CEILING INSTALLATION AS SHOWN. GENERAL CONTRACTOR TO NOTIFY ARCHITECT IMMEDIATELY OF ANY DISCREPANCY PRIOR TO COMMENCEMENT OF WORK. HEIGHTS INDICATED IN PARTITION TYPES SCHEDULE. CONFIRM ANY ALTERTERNATE SELECTED STUD SIZES, GAGES, OR O.C. SPACES IN WRITING PRIOR TO CONSTRUCTION. ROOM IDENTIFICATION EXISTING ELEC METER. EXISTING WALL 25. FRAME AROUND EXISTING DUCTWORK AS REQUIRED AT WALLS TO DECK AND GRID BREAK PARTITIONS. RELOCATED GAS METER 26. AT ALL MOVABLE PARTITION LOCATIONS, A CEILING TO SLAB INSULATED PARTITION IS TO BE CONSTRUCTED, FOR THE FULL WIDTH OF THE ROOM, TO PREVENT SOUND 6. ALL HOLES IN SLABS ARE TO BE FILLED WITH CODE-COMPLIANT FILLER. REFER TO TYPICAL PROJECT DETAILS. MAINTAIN THE EXISTING FLOOR SLAB RATING AT ALL FLOOR SLAB LOW SLOPE STANDING SEAM METAL ROOF PENETRATIONS AS REQUIRED BY U.L. DESIGN GUIDELINES. PROVIDE SNOW GUARD SYSTEM 27. SOUND LINED TRANSFER DUCTS ARE TO BE PROVIDED AT ALL ROOMS WITH SLAB TO SLAB PARTITIONS FOR RETURN AIR. 7. GENERAL CONTRACTOR TO FLASH PATCH ALL FLOORS AS REQUIRED TO RESTORE CONCRETE FLOORING TO LIKE NEW AND LEVEL CONDITION TO SATISFY ALL ASSEMBLY AND DEMOLISH WALL WINDOW IDENTIFICATION REFER TO A6.0 28. ALL PARTITIONS WITHIN WET AREAS SHALL BE WATER RESISTANT GYPSUM WALLBOARD (I.E. PANTRY SINK AREAS, REST ROOMS, ETC.). RELOCATED ELEC METER INSTALLATION REQUIREMENTS. REFER TO SPECIFICATIONS AND MANUFACTURER INSTRUCTIONS OF NEW FLOORING MATERIALS FOR MORE INFORMATION. 29. ALL UNFINISHED BASE BUILDING CORE WALLS, PERIMETER WALLS, OR COLUMNS ARE TO BE FURRED OUT WITH GYPSUM BOARD

30. PROVIDE FIRE TREATED WOOD BLOCKING OR METAL BLOCKING IN WALLS AS REQUIRED FOR SECURE INSTALLATION OF ALL MILLWORK, DOORS, WINDOWS, AND ACCESSORIES. RELOCATE EXISTING CAT 5 TO ROOF AND RELOCATE CONDUIT TO ROOF . REMOVE FROM EXISTING EXTERIOR WALL. 8. GENERAL CONTRACTOR TO PATCH ALL SURFACES TO MATCH ADJACENT SURFACES IN A MANNER SUITABLE TO RECEIVE FINISHES. 9, GENERAL CONTRACTOR TO PATCH AND PAINT TO RESTORE TO LIKE NEW CONDITION ALL INTERIOR PERIMETER MULLIONS, COMPONENTS, AND WALLS ALONG BUILDING HOSE BID.. SEE PLUMBING DWGS. REFER TO MANUFACTURER'S INSTALLATION INSTRUCTIONS FOR SPECIFIC BLOCKING REQUIREMENTS. PRESSURE WASHER. SEE MEP DRAWINGS 31. ALL DOORS ARE EXISTING TO REMAIN UNLESS OTHERWISE NOTED. REFER TO SHEET A6.0 FOR DOOR HARDWARE SCHEDULE. 10. ALL NEW DIMENSIONS ARE FROM FINISH SURFACE TO FINISH SURFACE, UNLESS NOTED OTHERWISE. DOOR IDENTIFICATION REFER TO A6.0 AIRVAC SYSTEM NOT IN SCOPE 32. ALL DOORS, MILLWORK, DEVICES, ETC. SCHEDULED TO REMAIN ARE TO BE CLEANED, TESTED, SERVICED IF REQUIRED, AND RESTORED TO FULL OPERATING CONDITION. 11. ALL PARTITIONS TO BE FULL HEIGHT FROM SLAB TO STRUCTURE ABOVE, WITH ONE LAYER OF GYPSUM WALLBOARD ON EACH SIDE OF METAL STUD TO 6" ABOVE CEILING HEIGHT, FINISHES TO BE REPAIRED AND RESTORED TO LIKE NEW CONDITION. FUR OUT EXISTING CMU WALL 33. POROUS OR FIBROUS MATERIALS AND OTHER MATERIALS SUBJECT TO MOISTURE DAMAGE SHALL BE PROTECTED FROM MOISTURE DURING THE CONSTRUCTION PHASE. 12. VERIFY HEIGHT OF ABOVE CEILING STRUCTURE AFTER DEMOLITION OF CEILING. NOTIFY ARCHITECT OF ANY CONFLICT BETWEEN HEIGHT OF STRUCTURE AND LIMITING HEIGHTS MATERIAL DAMAGED BY MOISTURE EITHER PRIOR TO DELIVERY OR DURING THE CONSTRUCTION PHASE SHALL BE CLEANED AND DRIED OR, WHERE DAMAGE CANNOT BE INDICATED IN PARTITION TYPES SCHEDULE. CONFIRM ANY ALTERTERNATE SELECTED STUD SIZES, GAGES, OR O.C. SPACES IN WRITING PRIOR TO CONSTRUCTION. WALL ASSEMBLY TYPE REFER TO A5.0 CORRECTED BY SUCH MEANS, SHALL BE REMOVED AND REPLACED. 13. FRAME AROUND EXISTING DUCTWORK AS REQUIRED AT WALLS TO DECK AND GRID BREAK PARTITIONS. 34. POWER LOCATIONS SHOWN IN ARCHITECTURAL PLAN ARE FOR REFERENCE AND FINAL LOCATION ONLY. SEE ELECTRICAL DRAWINGS FOR ALL LOCATIONS AND SPECS OF 14. AT ALL MOVABLE PARTITION LOCATIONS, A CEILING TO SLAB INSULATED PARTITION IS TO BE CONSTRUCTED, FOR THE FULL WIDTH OF THE ROOM, TO PREVENT SOUND ELECTRICAL FIXTURES. 15, SOUND LINED TRANSFER DUCTS ARE TO BE PROVIDED AT ALL ROOMS WITH SLAB TO SLAB PARTITIONS FOR RETURN AIR. 16. ALL PARTITIONS WITHIN WET AREAS SHALL BE WATER RESISTANT GYPSUM WALLBOARD (I.E. PANTRY SINK AREAS, REST ROOMS, ETC.). DOOR SWING CLEARANCE 17. ALL UNFINISHED BASE BUILDING CORE WALLS, PERIMETER WALLS, OR COLUMNS ARE TO BE FURRED OUT WITH GYPSUM BOARD ROOF, OR FLOOR / CEILING 18. PROVIDE FIRE TREATED WOOD BLOCKING OR METAL BLOCKING IN WALLS AS REQUIRED FOR SECURE INSTALLATION OF ALL MILLWORK, DOORS, WINDOWS, AND ACCESSORIES. REFER TO G1.5 ASSEMBLY TYPE REFER TO MANUFACTURER'S INSTALLATION INSTRUCTIONS FOR SPECIFIC BLOCKING REQUIREMENTS. 19. ALL DOORS ARE EXISTING TO REMAIN UNLESS OTHERWISE NOTED. REFER TO SHEET A6.0 FOR DOOR HARDWARE SCHEDULE.



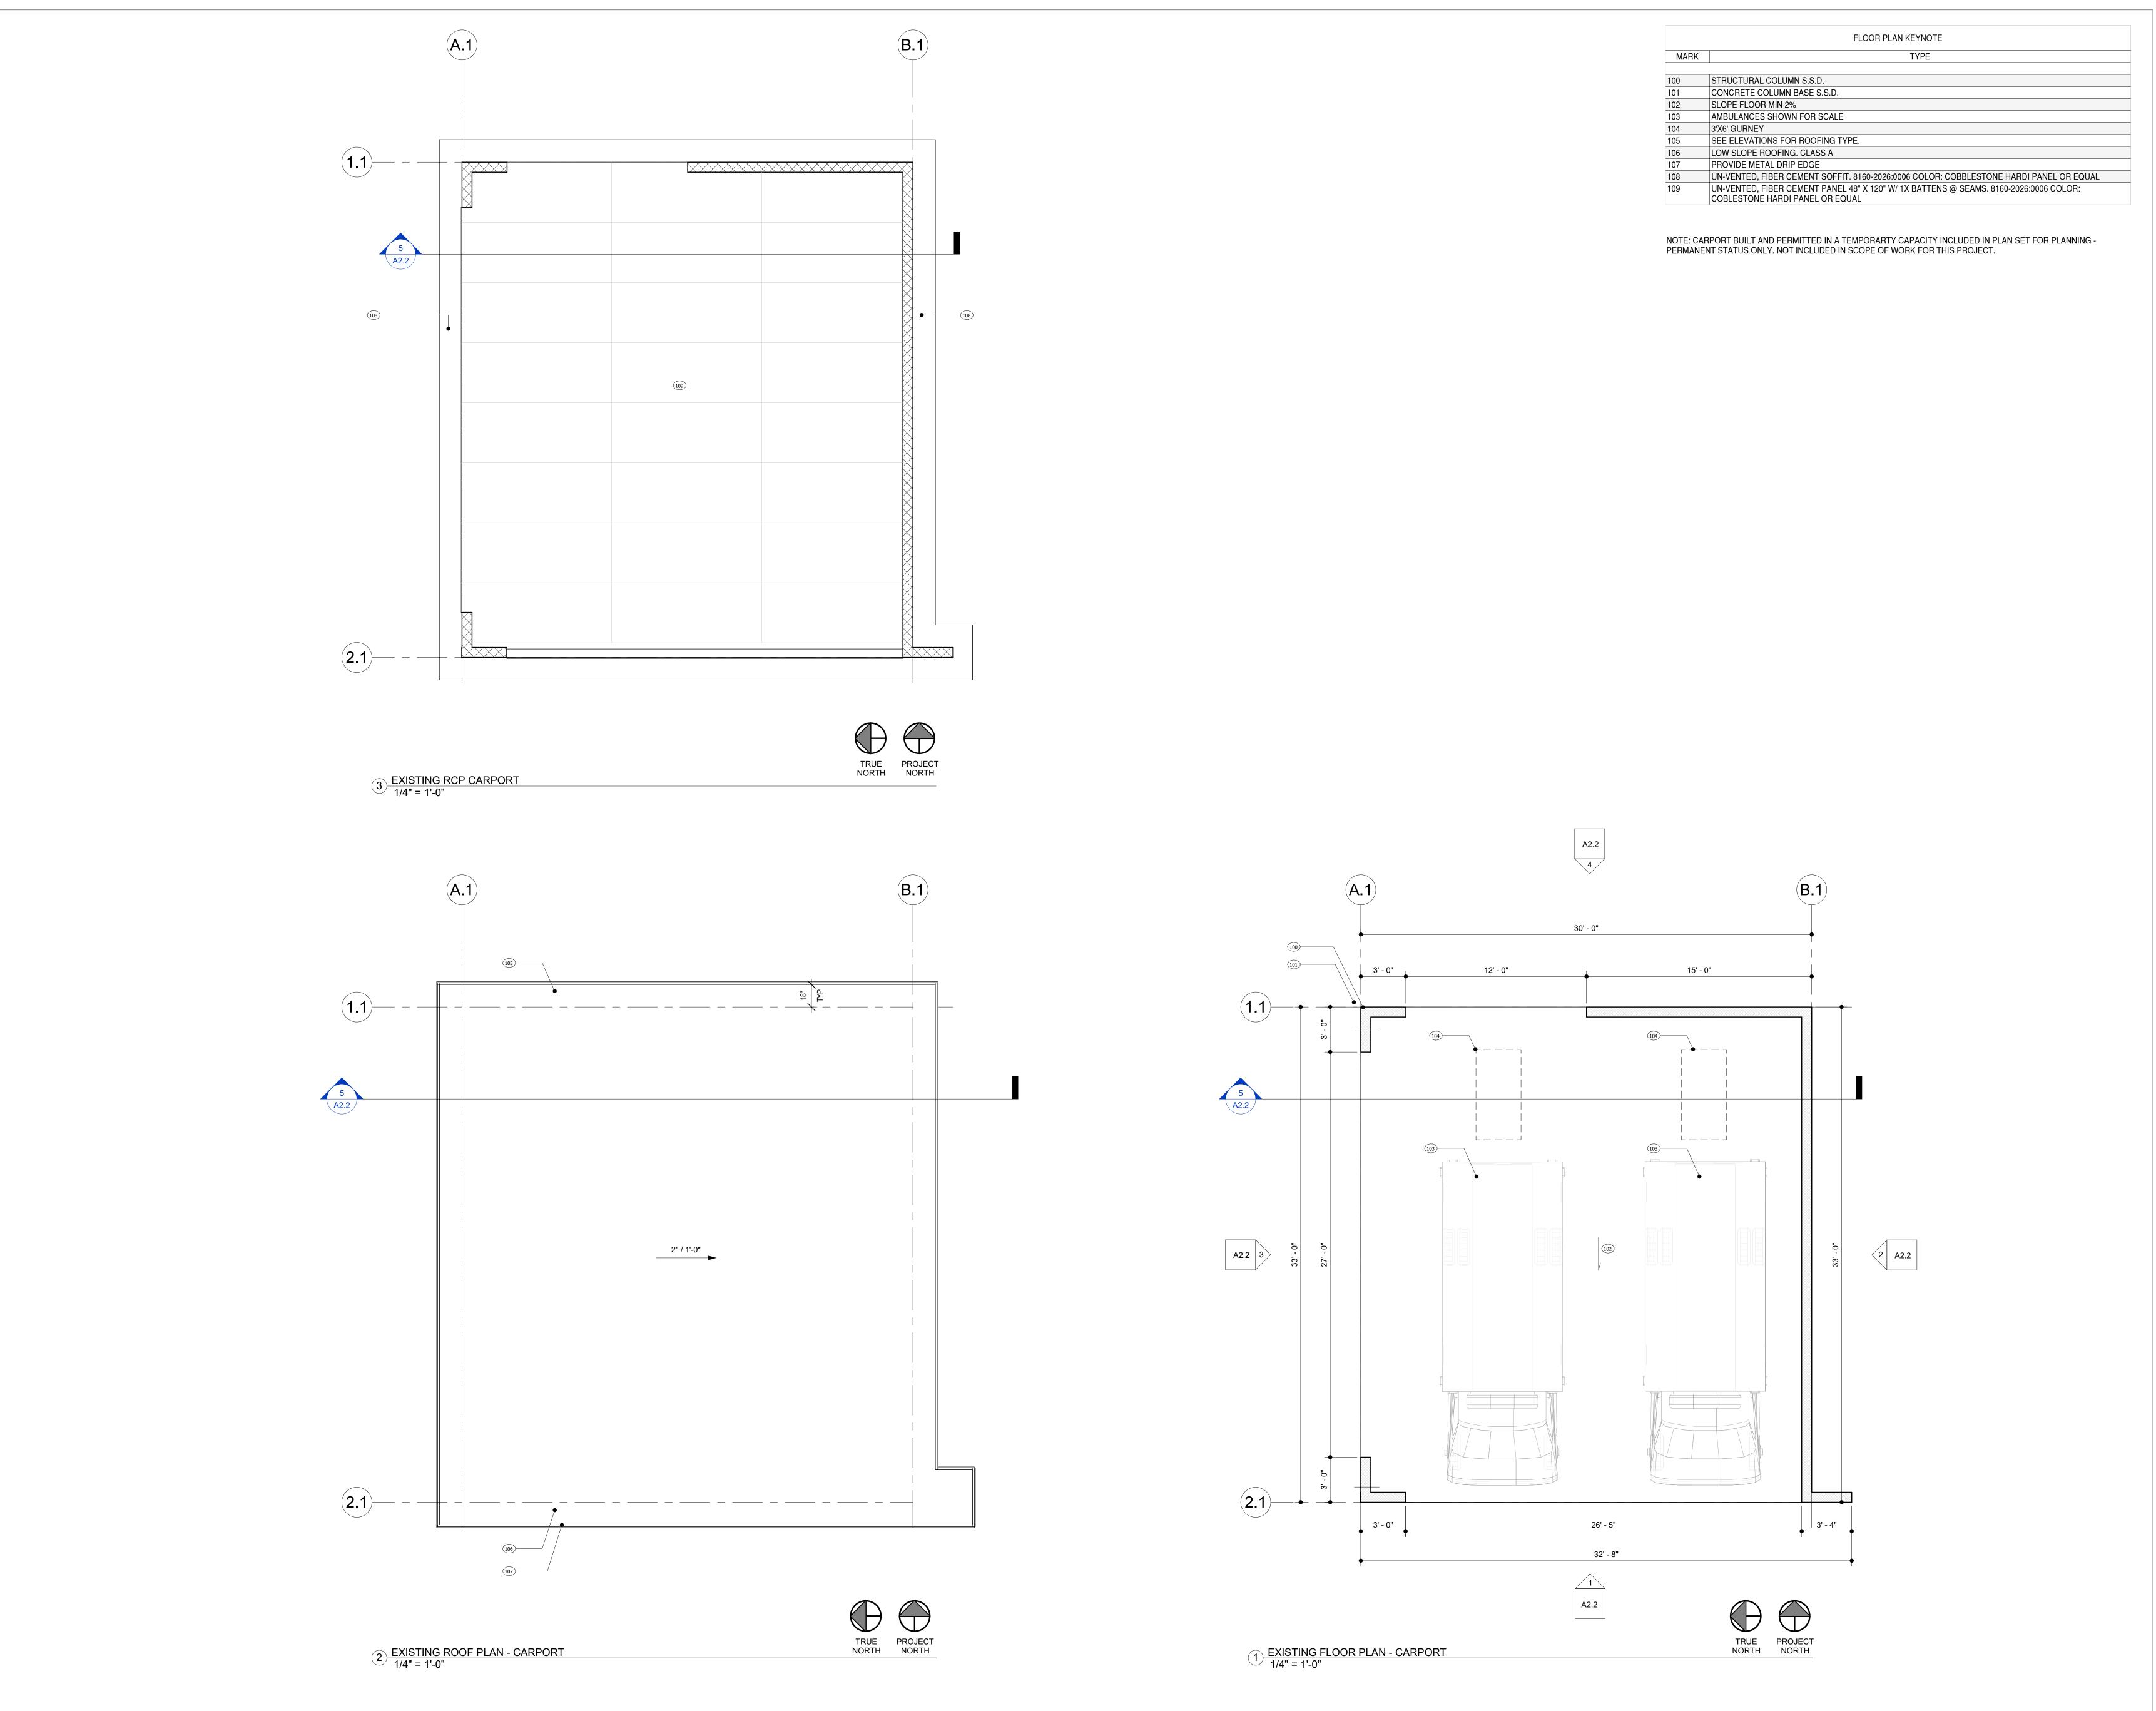

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ARCHITECTURAL PROPOSED CARPORT FLOOR PLANS

CALIFORNIA TAHOE EMERGENCY SERVICES OPERATIONS AUTHORITY


3066 LAKE TAHOE BLVD.


04.21.2023

A1.7

Date 04.21.23 07.07.23

95% CD PHASE

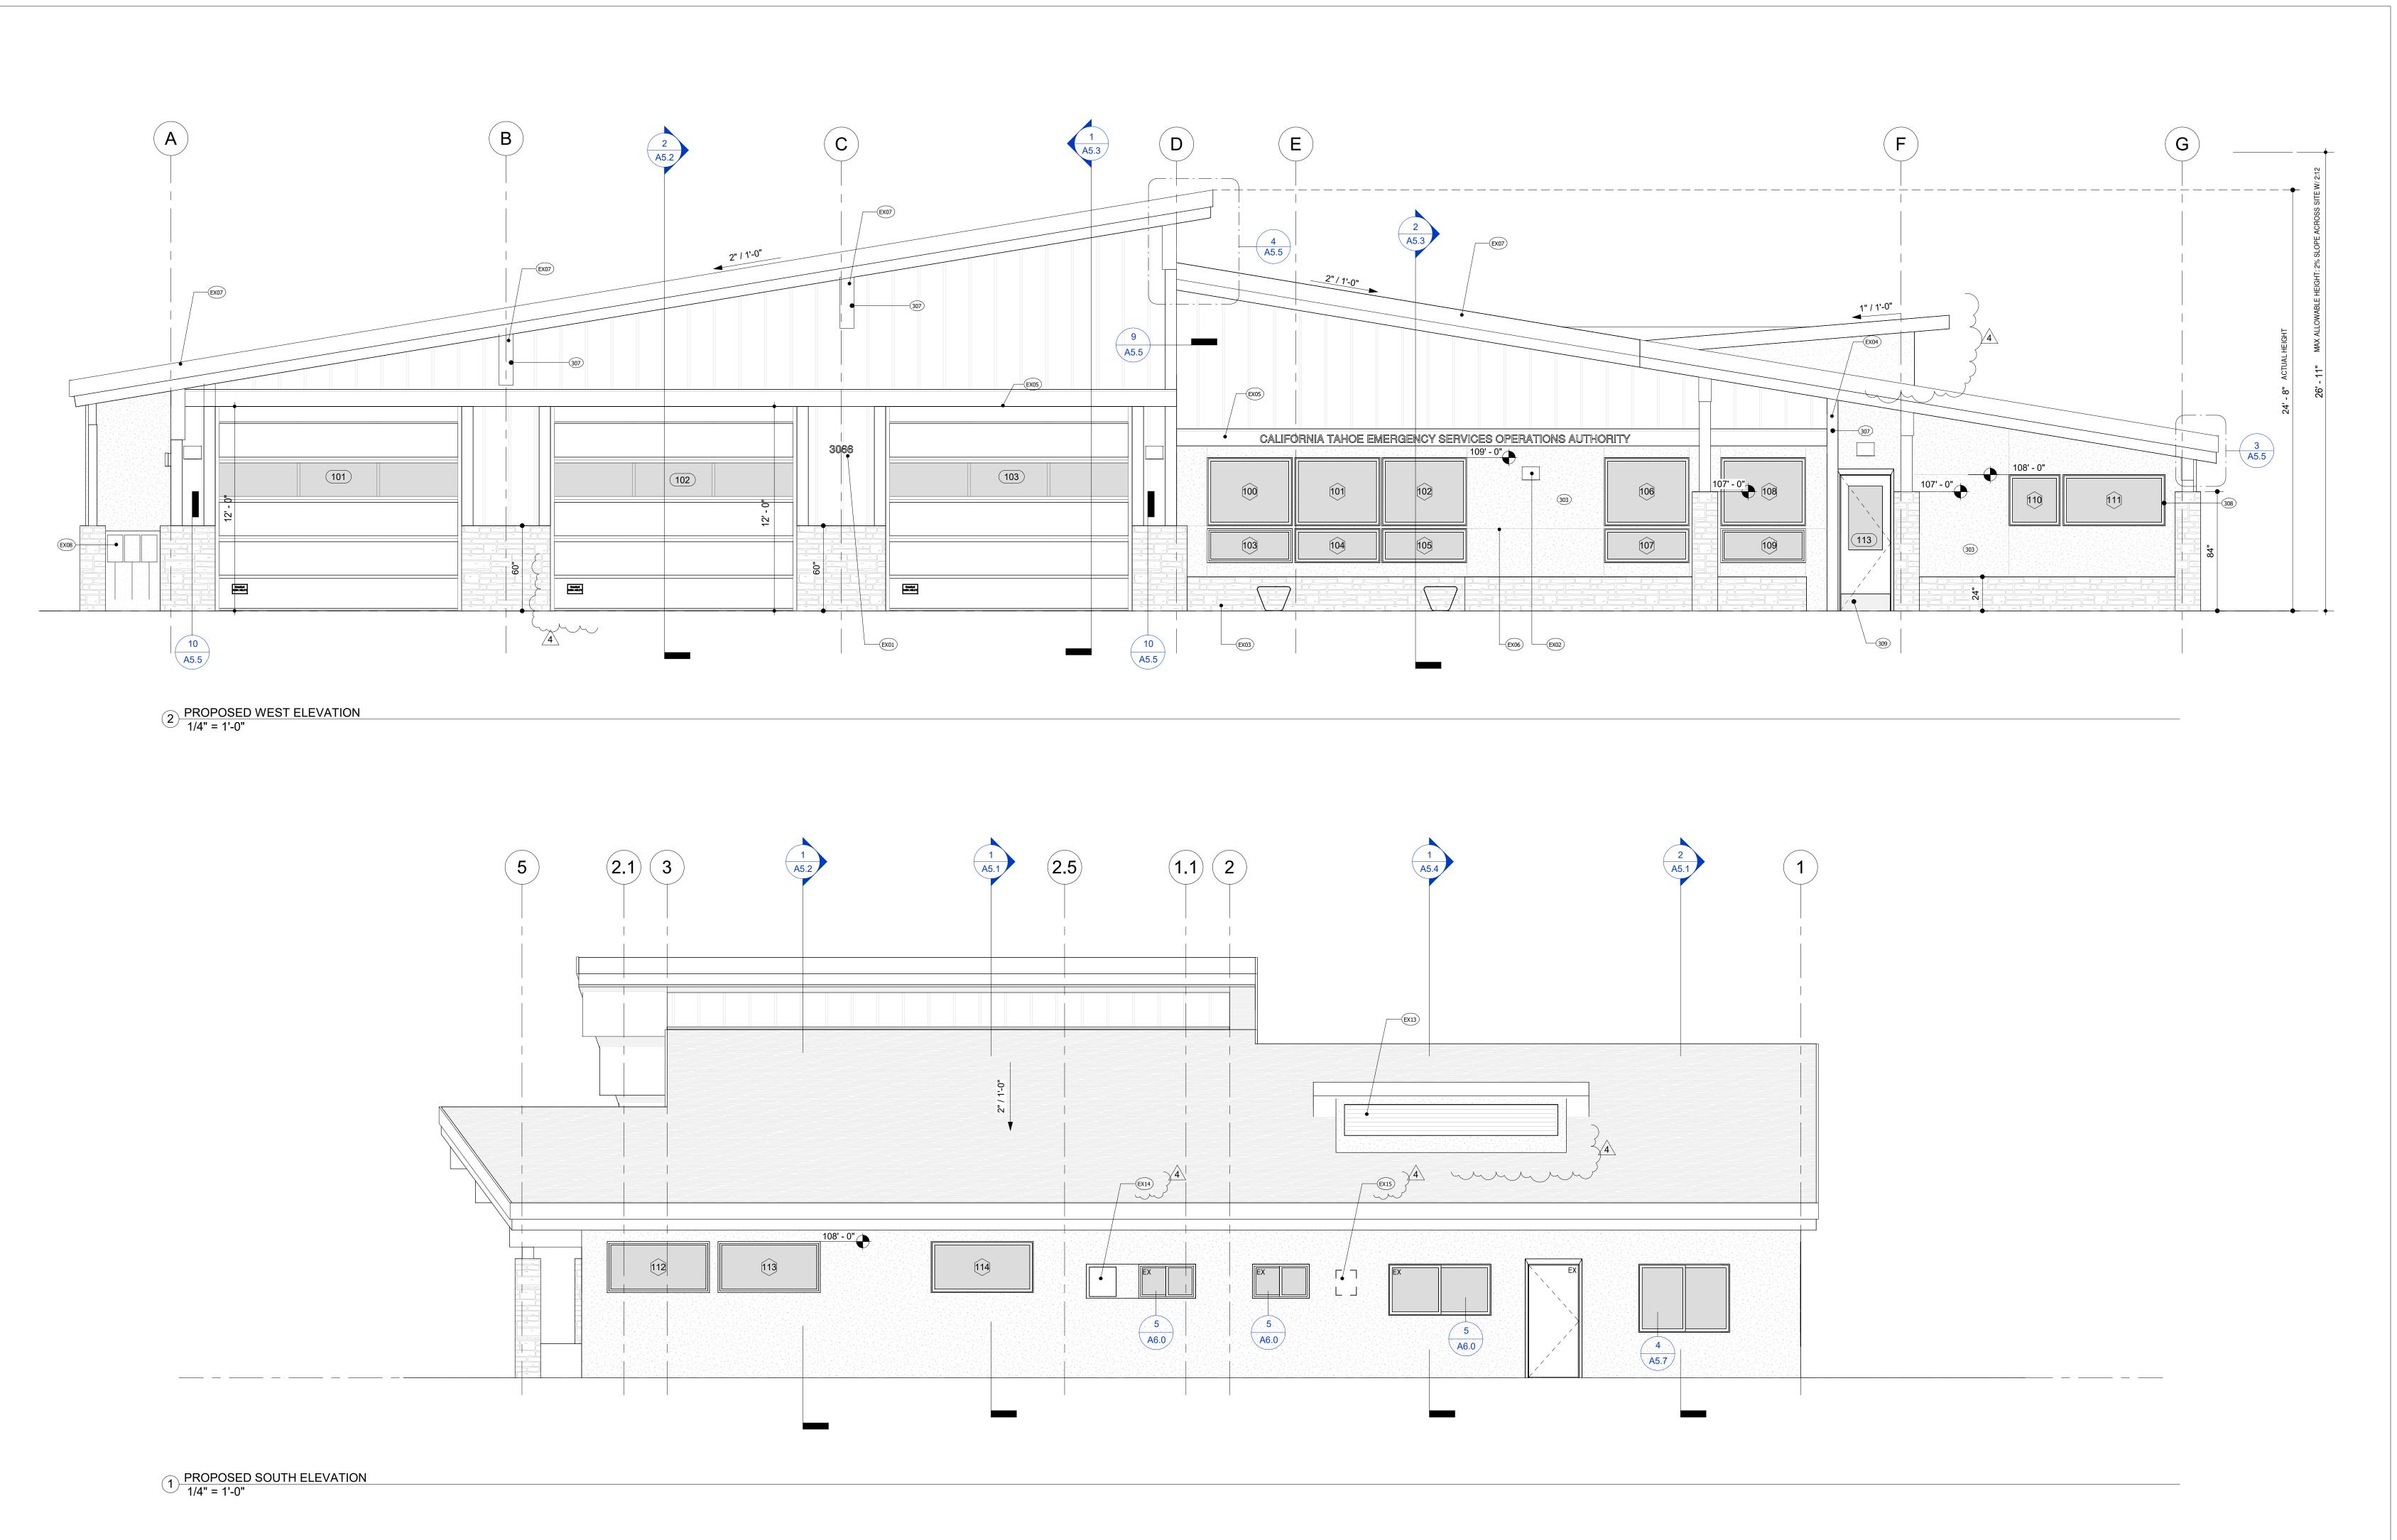

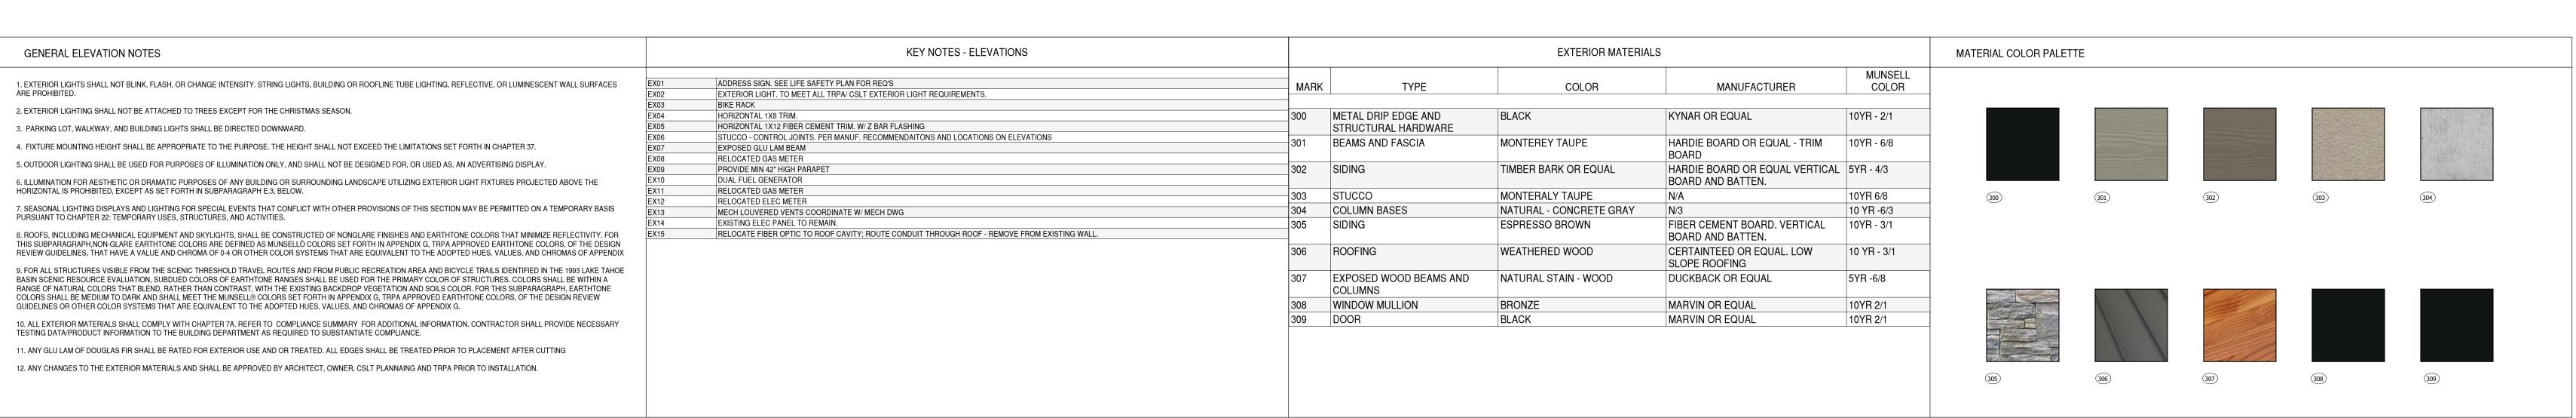



530.542.2919

ELEVATIONS - WEST & SOUTH
CALIFORNIA TAHOE EMERGENCY SERVICES OPERATIONS AUTH

 Project Number
 211008

 Date
 04.21.2023

 95% CD PHASE

 No.
 Description
 Date

 1
 TRPA_BID_SUBMITTAL
 04.21.23


 2
 BID SET II
 07.07.23


 3
 ELDO COUNTY BUILDING
 02.20.24

 DEPT PC1
 4
 GC RFI Responses
 03.20.24

Drawn By BM

A2.0

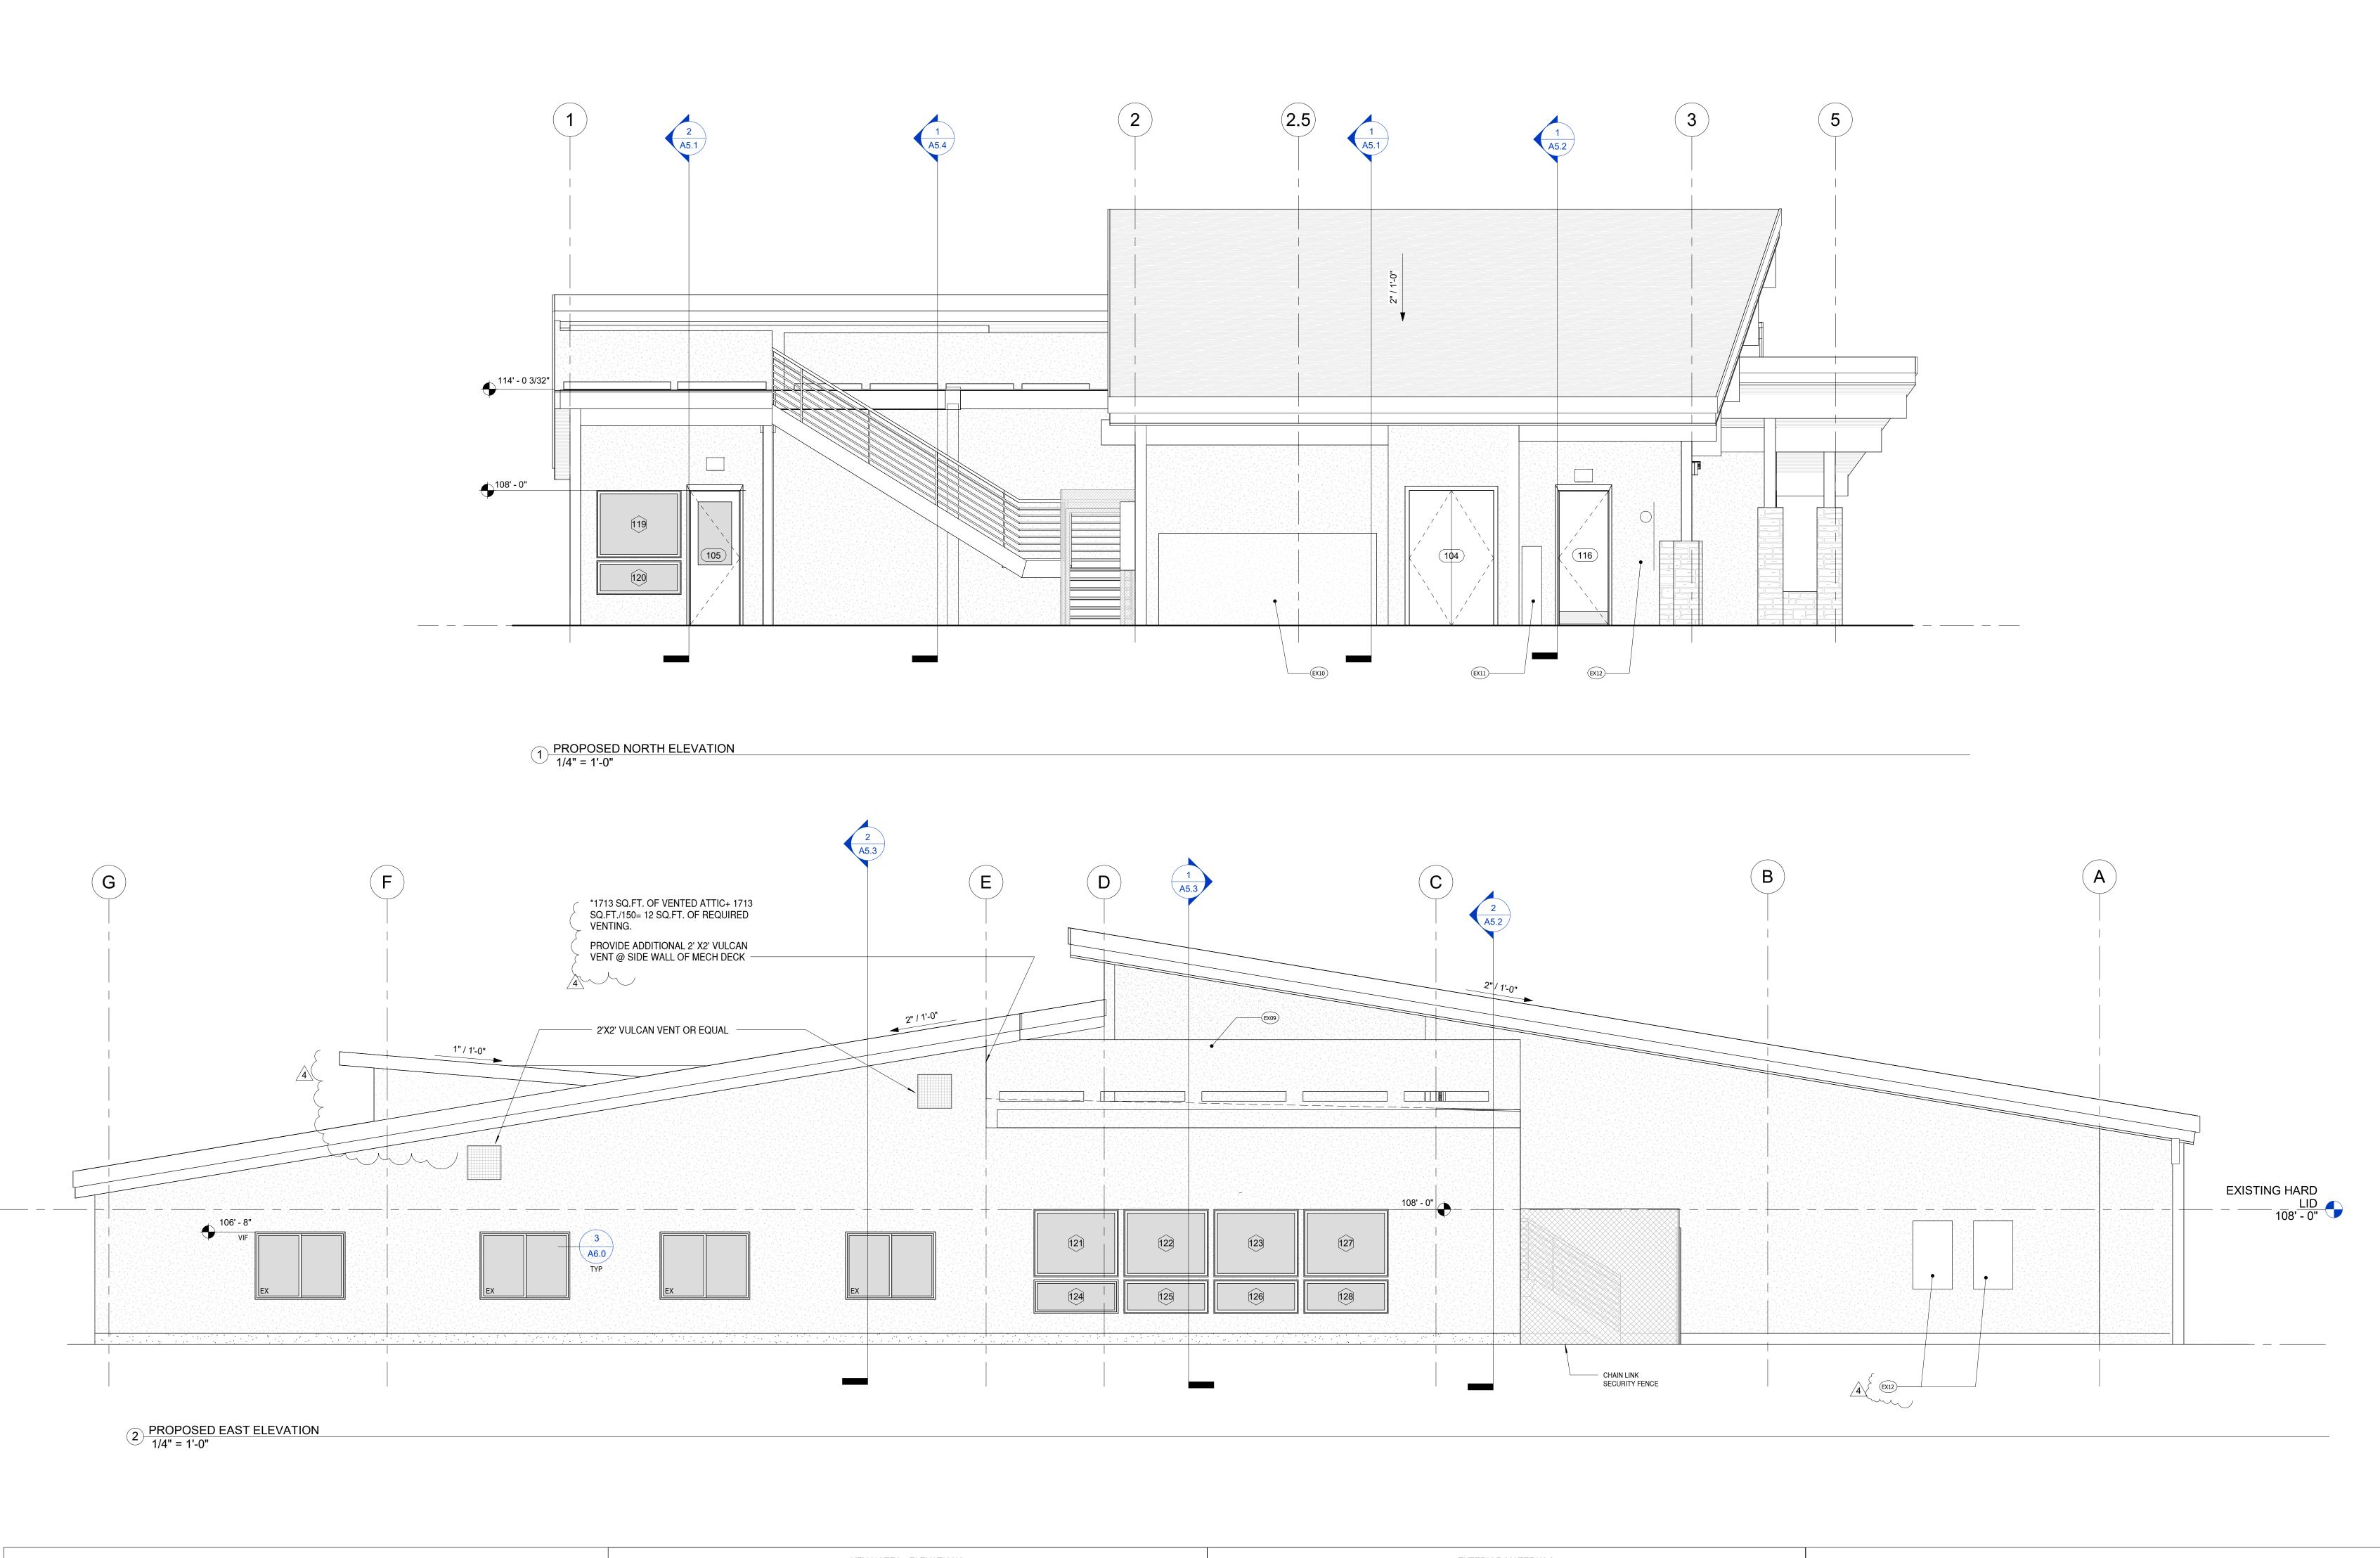

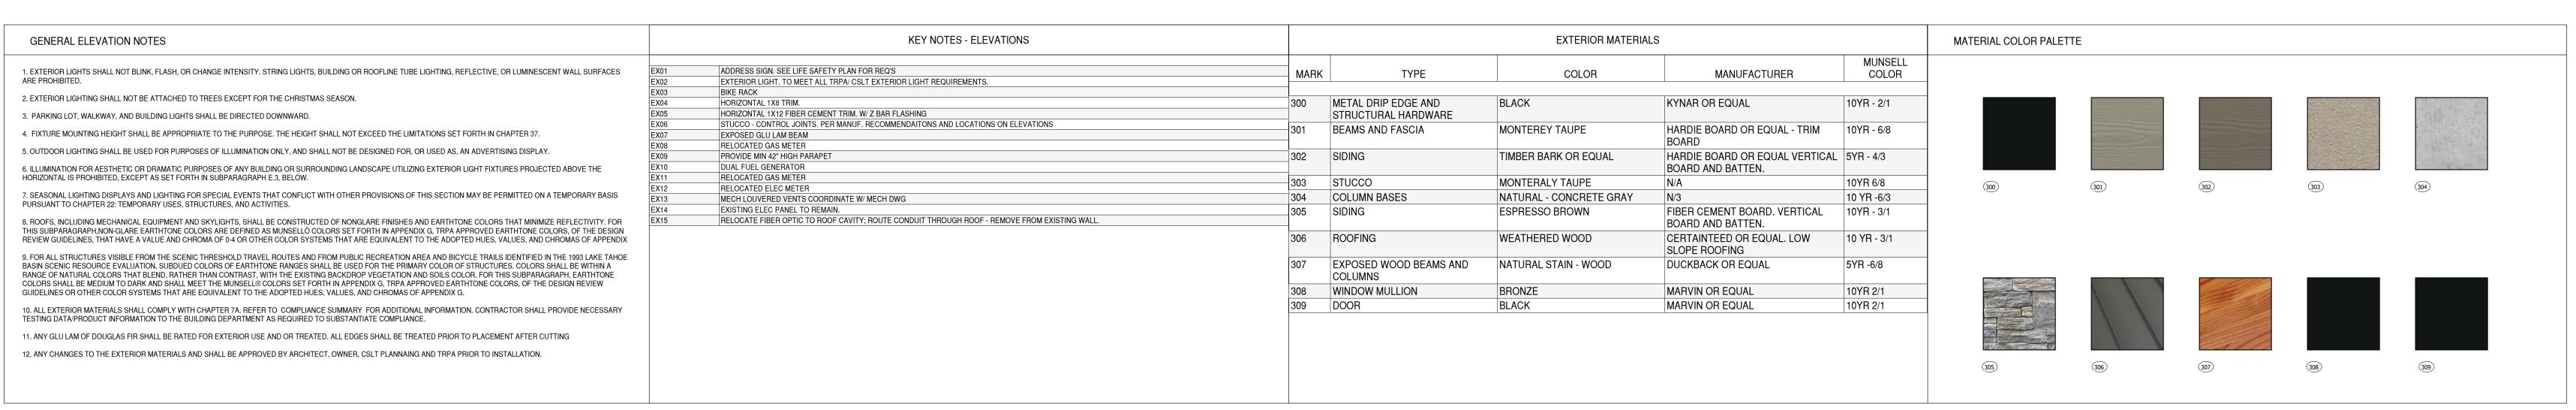



ELEVATIONS - EAST & NORTH

CALIFORNIA TAHOE EMERGENCY SERVICES OPERATIONS A
3066 LAKE TAHOE BLVD.

Drawn By BM


Project Number 211008

Date 04.21.2023

95% CD PHASE


1 TRPA_BID_SUBMITTAL 04.21.23
2 BID SET II 07.07.23
3 ELDO COUNTY BUILDING 02.20.24
DEPT PC1
4 GC RFI Responses 03.20.24

A2.1

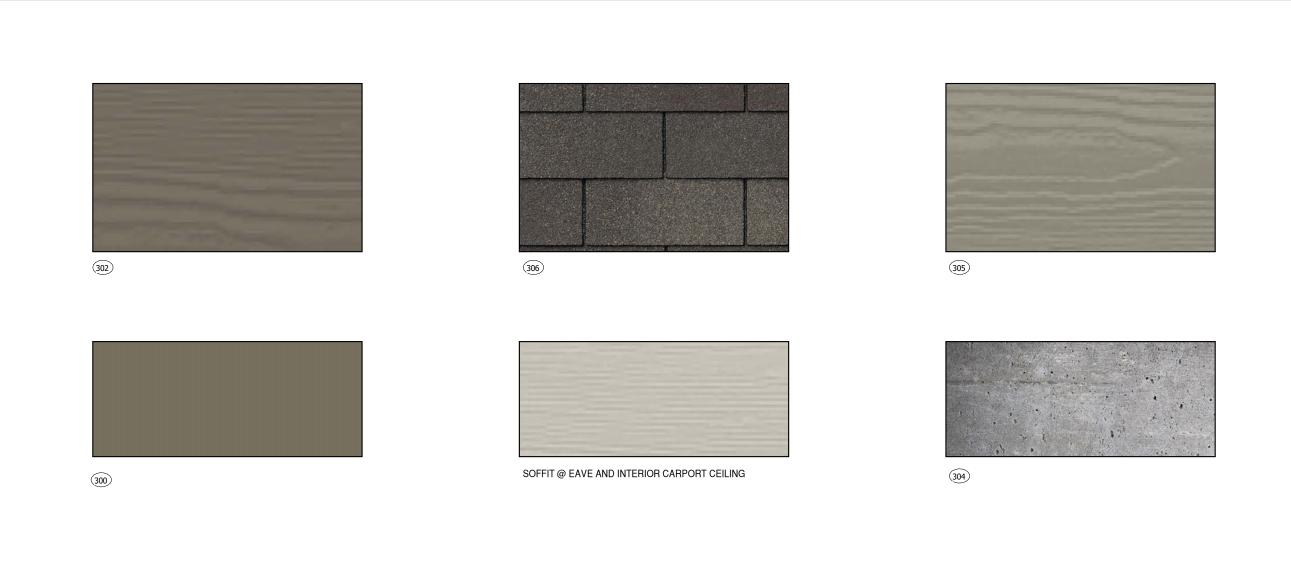



		EXTERIOR MATERIAL		
MARK	TYPE	COLOR	MANUFACTURER	MUNSEL COLOR
300	METAL DRIP EDGE AND STRUCTURAL HARDWARE	BLACK	KYNAR OR EQUAL	10YR - 2/1
301	BEAMS AND FASCIA	MONTEREY TAUPE	HARDIE BOARD OR EQUAL - TRIM BOARD	10YR - 6/8
302	SIDING	TIMBER BARK OR EQUAL	HARDIE BOARD OR EQUAL VERTICAL BOARD AND BATTEN.	5YR - 4/3
303	STUCCO	MONTERALY TAUPE	N/A	10YR 6/8
304	COLUMN BASES	NATURAL - CONCRETE GRAY	N/3	10 YR -6/3
305	SIDING	ESPRESSO BROWN	FIBER CEMENT BOARD. VERTICAL BOARD AND BATTEN.	10YR - 3/1
306	ROOFING	WEATHERED WOOD	CERTAINTEED OR EQUAL. LOW SLOPE ROOFING	10 YR - 3/1
307	EXPOSED WOOD BEAMS AND COLUMNS	NATURAL STAIN - WOOD	DUCKBACK OR EQUAL	5YR -6/8
308	WINDOW MULLION	BRONZE	MARVIN OR EQUAL	10YR 2/1
309	DOOR	BLACK	MARVIN OR EQUAL	10YR 2/1




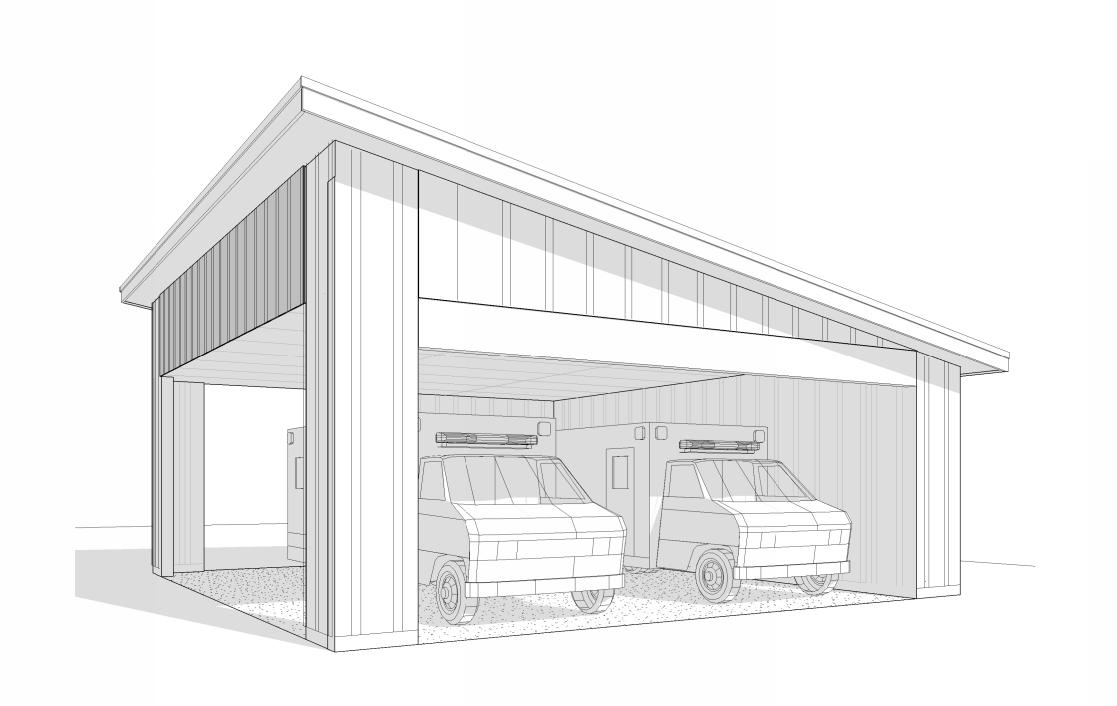



7 3D CARPORT VIEW

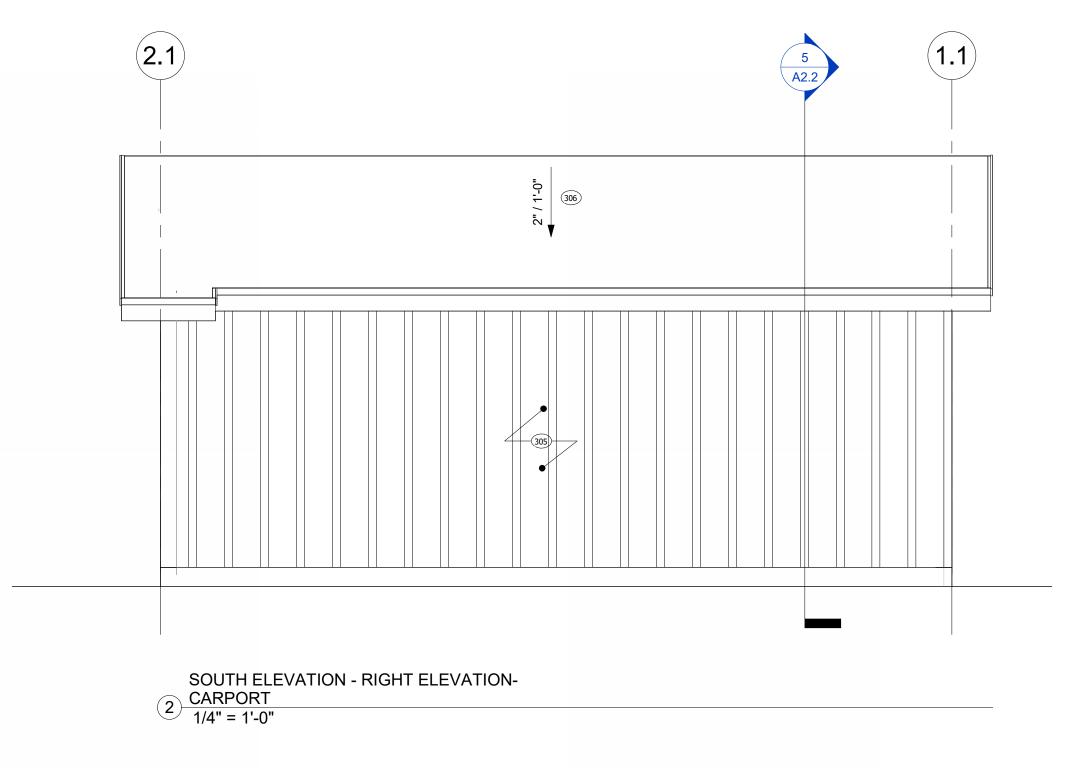

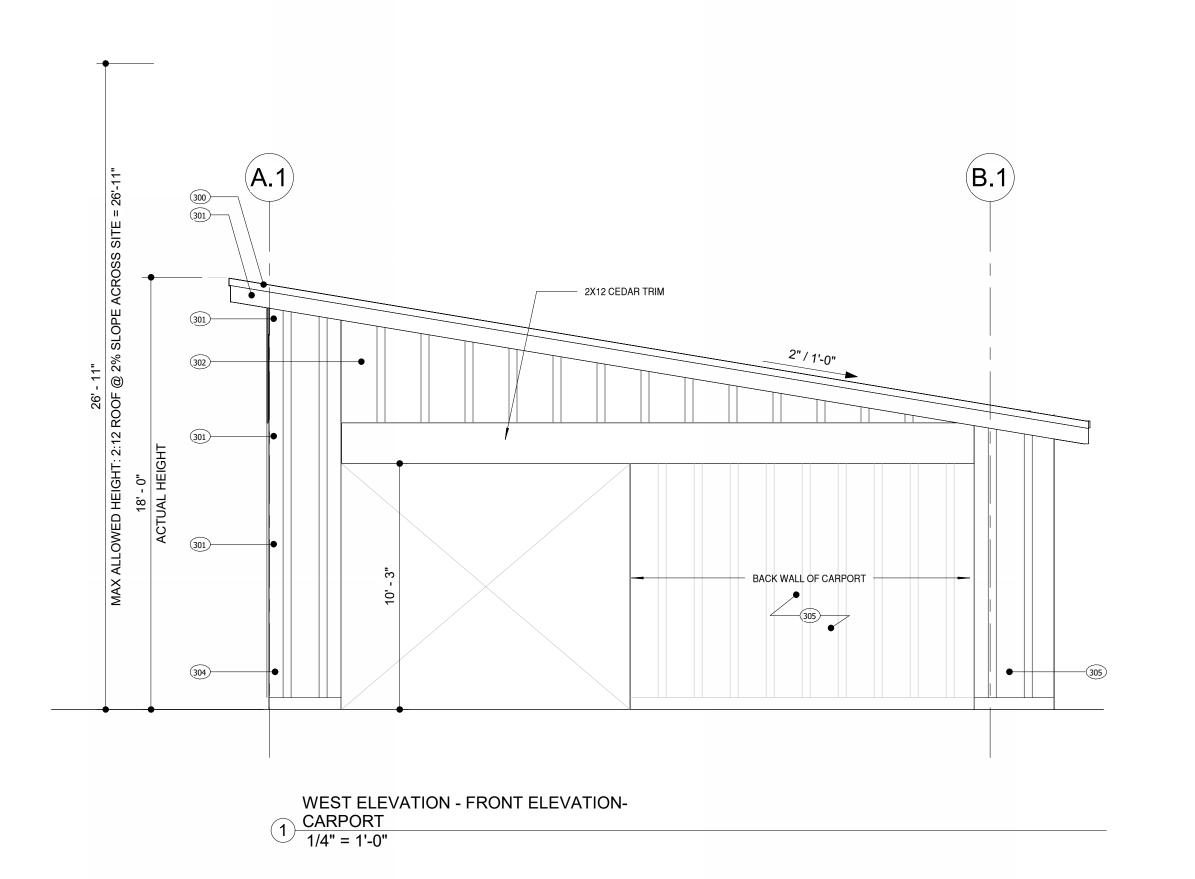

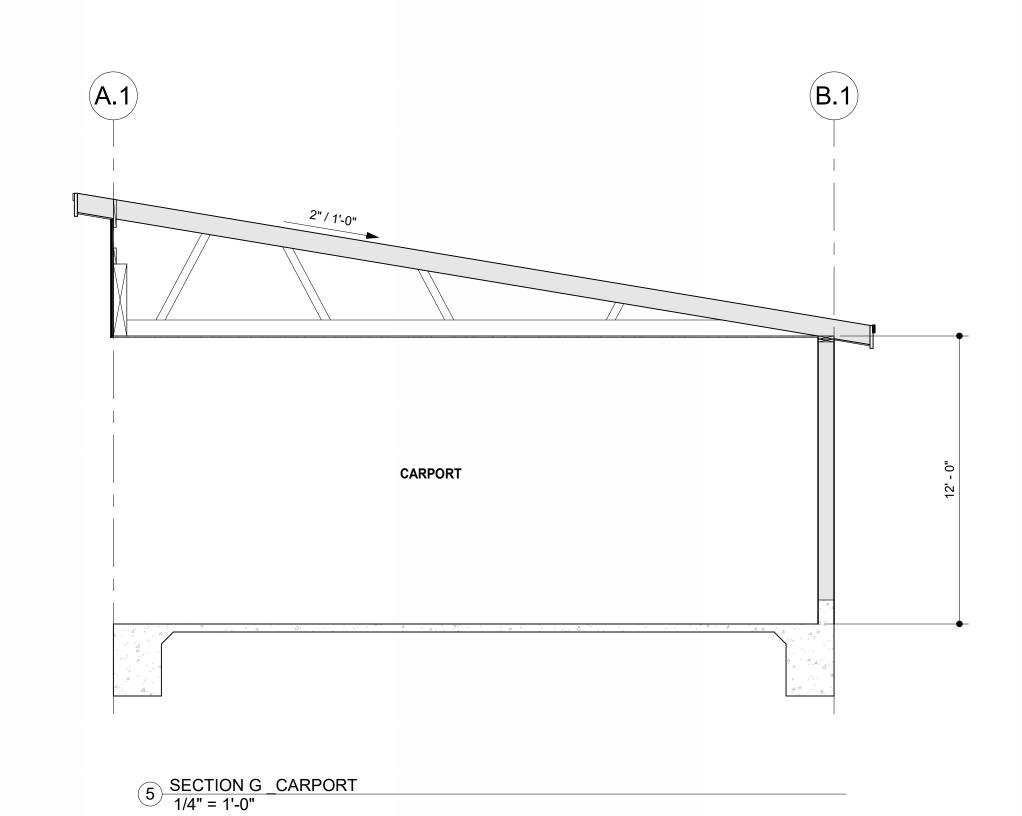

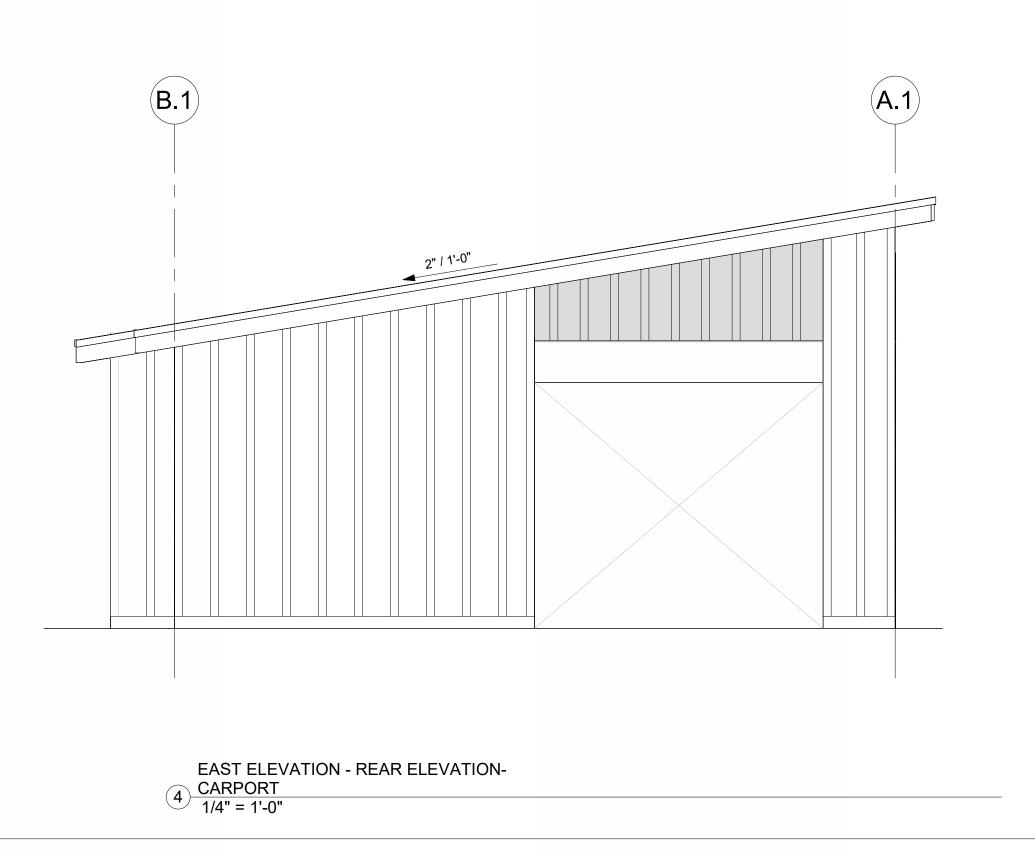


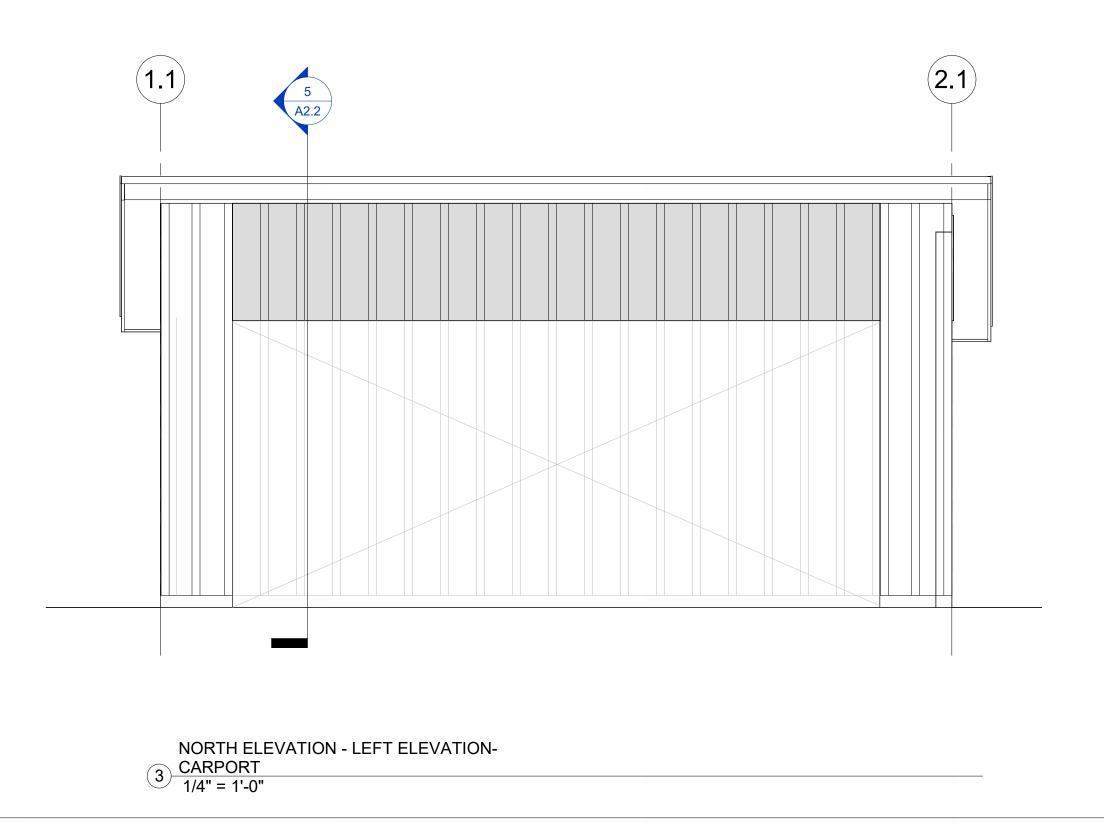



Drawn By BM
Project Number 211008
Date 04.21.2023
95% CD PHASE

No. Description Date 1 TRPA_BID_SUBMITTAL 04.21.23

A21.2

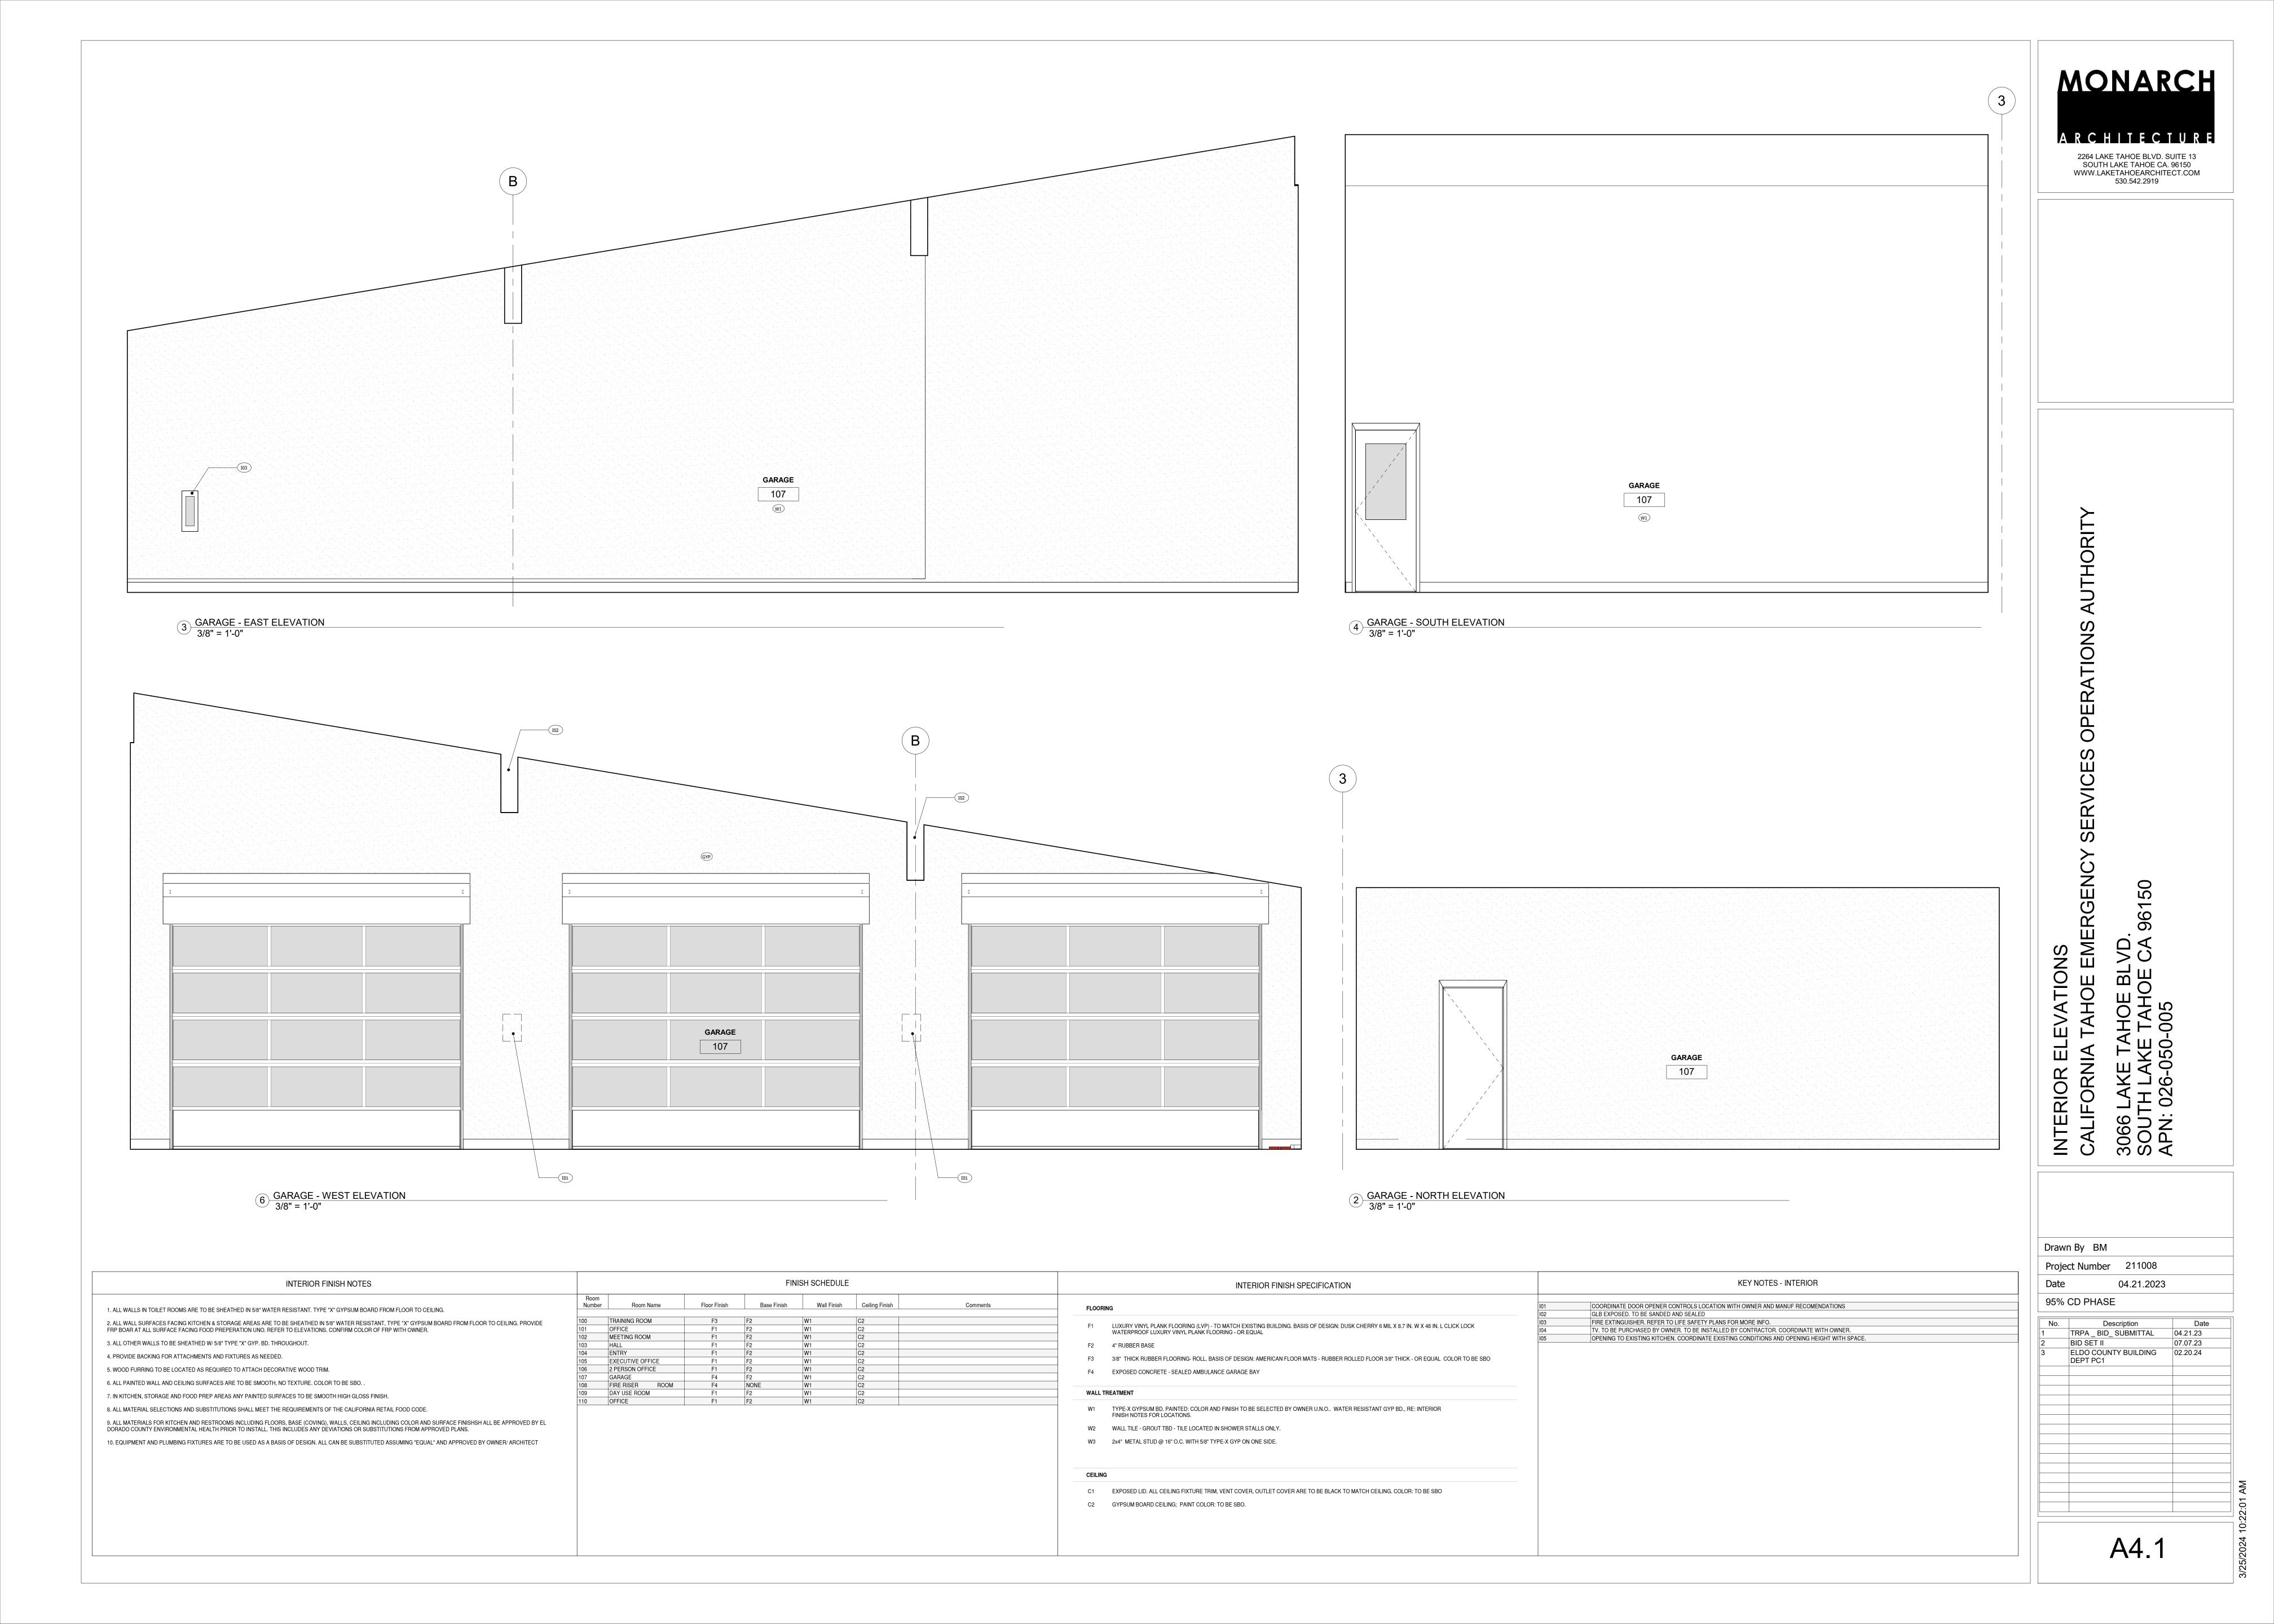

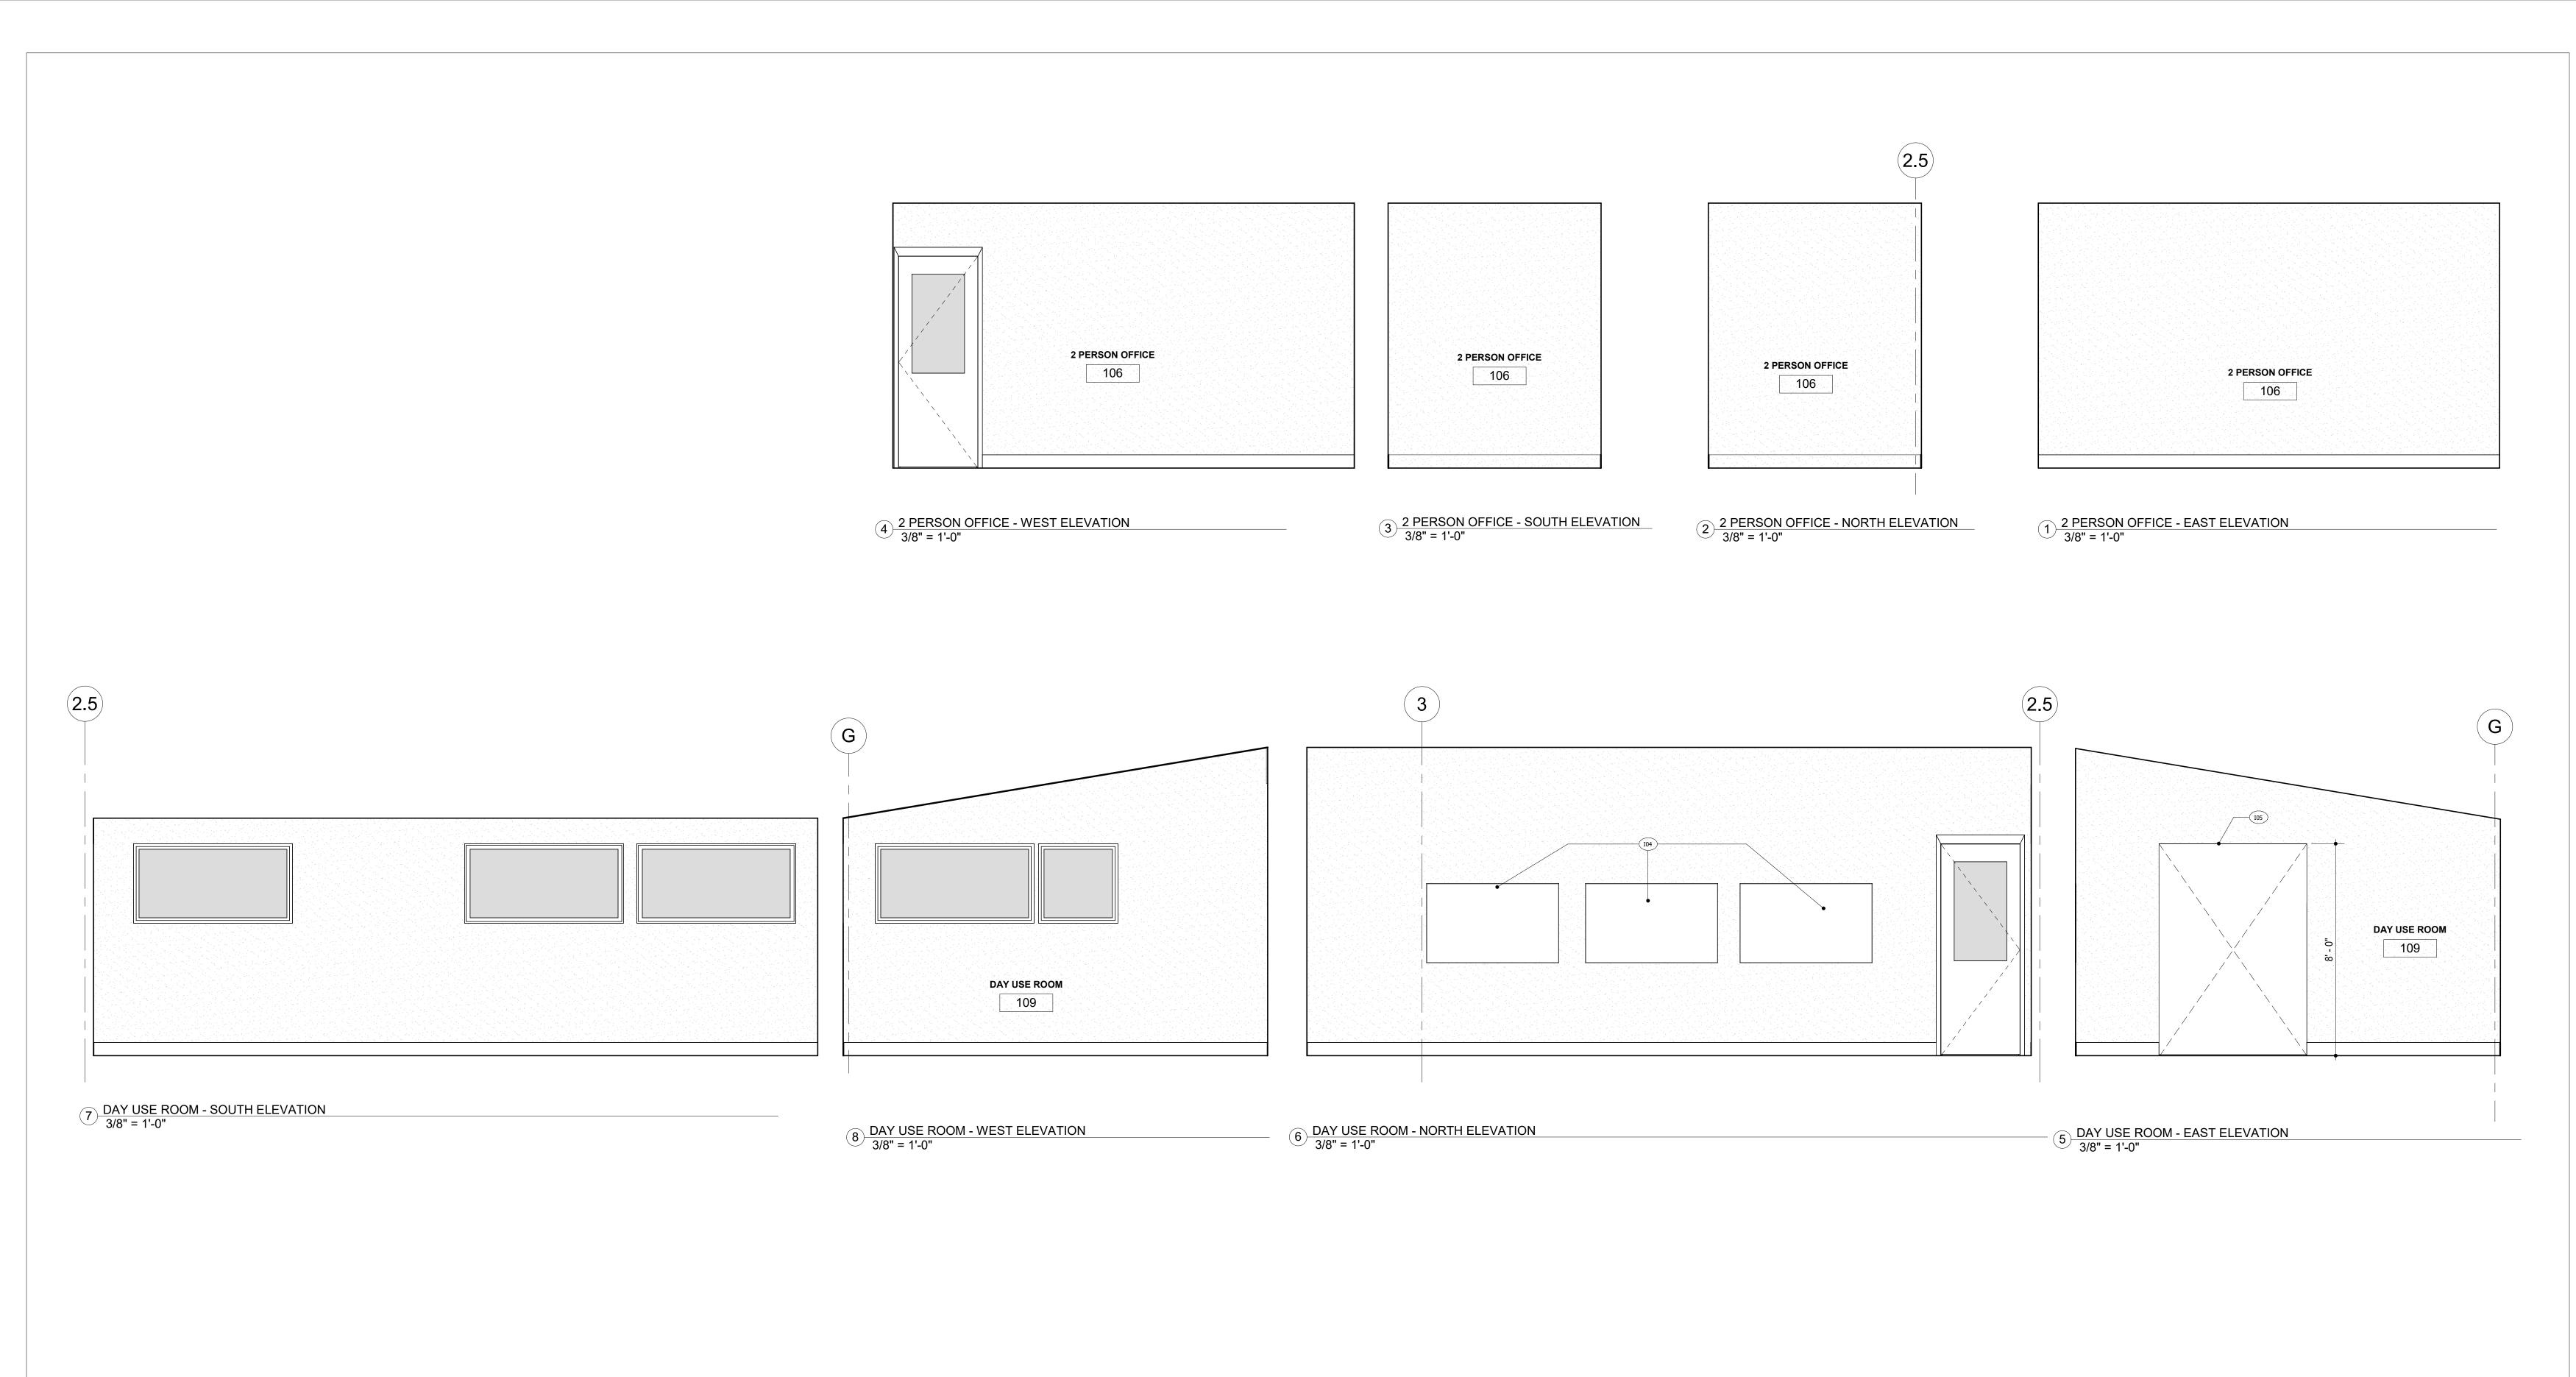

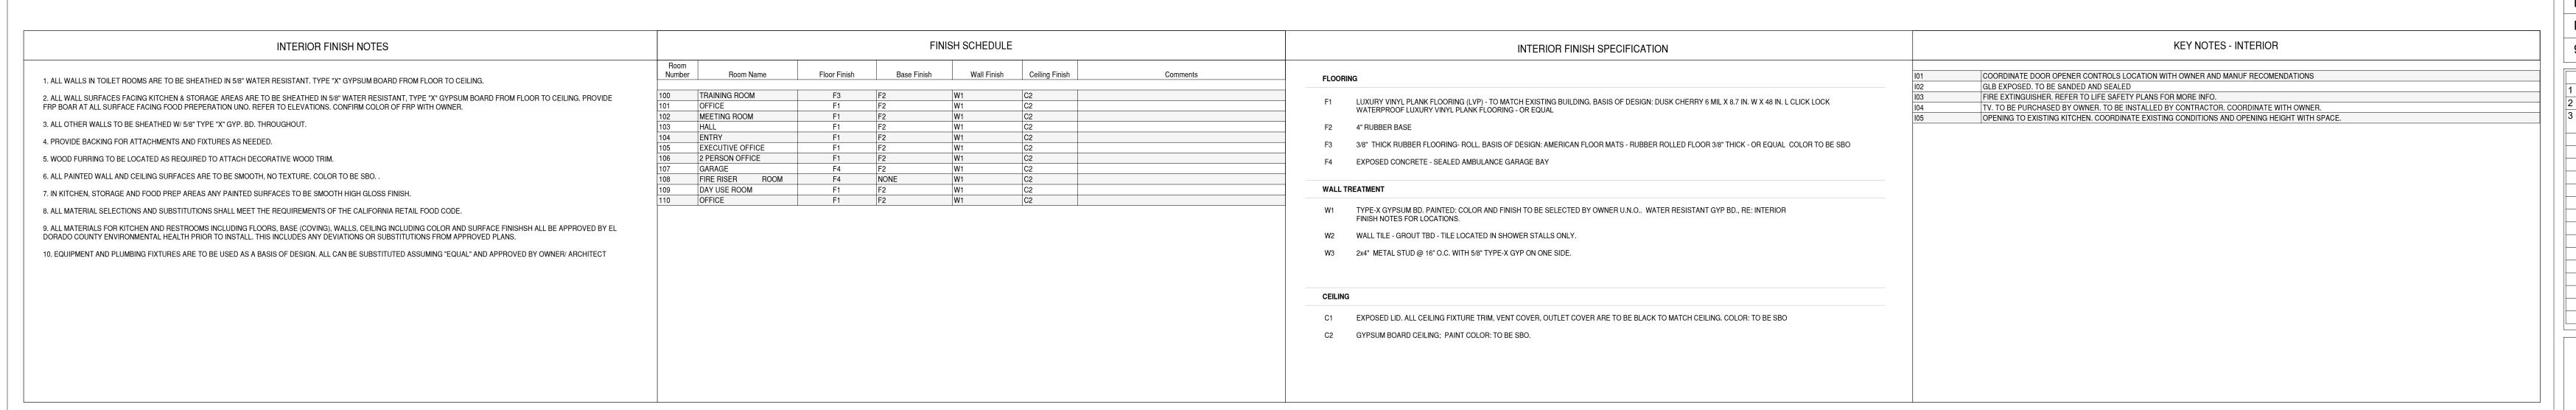





SERVICES ELEVATIONS IIA TAHOE EMERGENC

Drawn By BM Project Number 211008 04.21.2023 95% CD PHASE

TRPA_BID_SUBMITTAL
BID SET II 04.21.23 07.07.23 3 ELDO COUNTY BUILDING 02.20.24

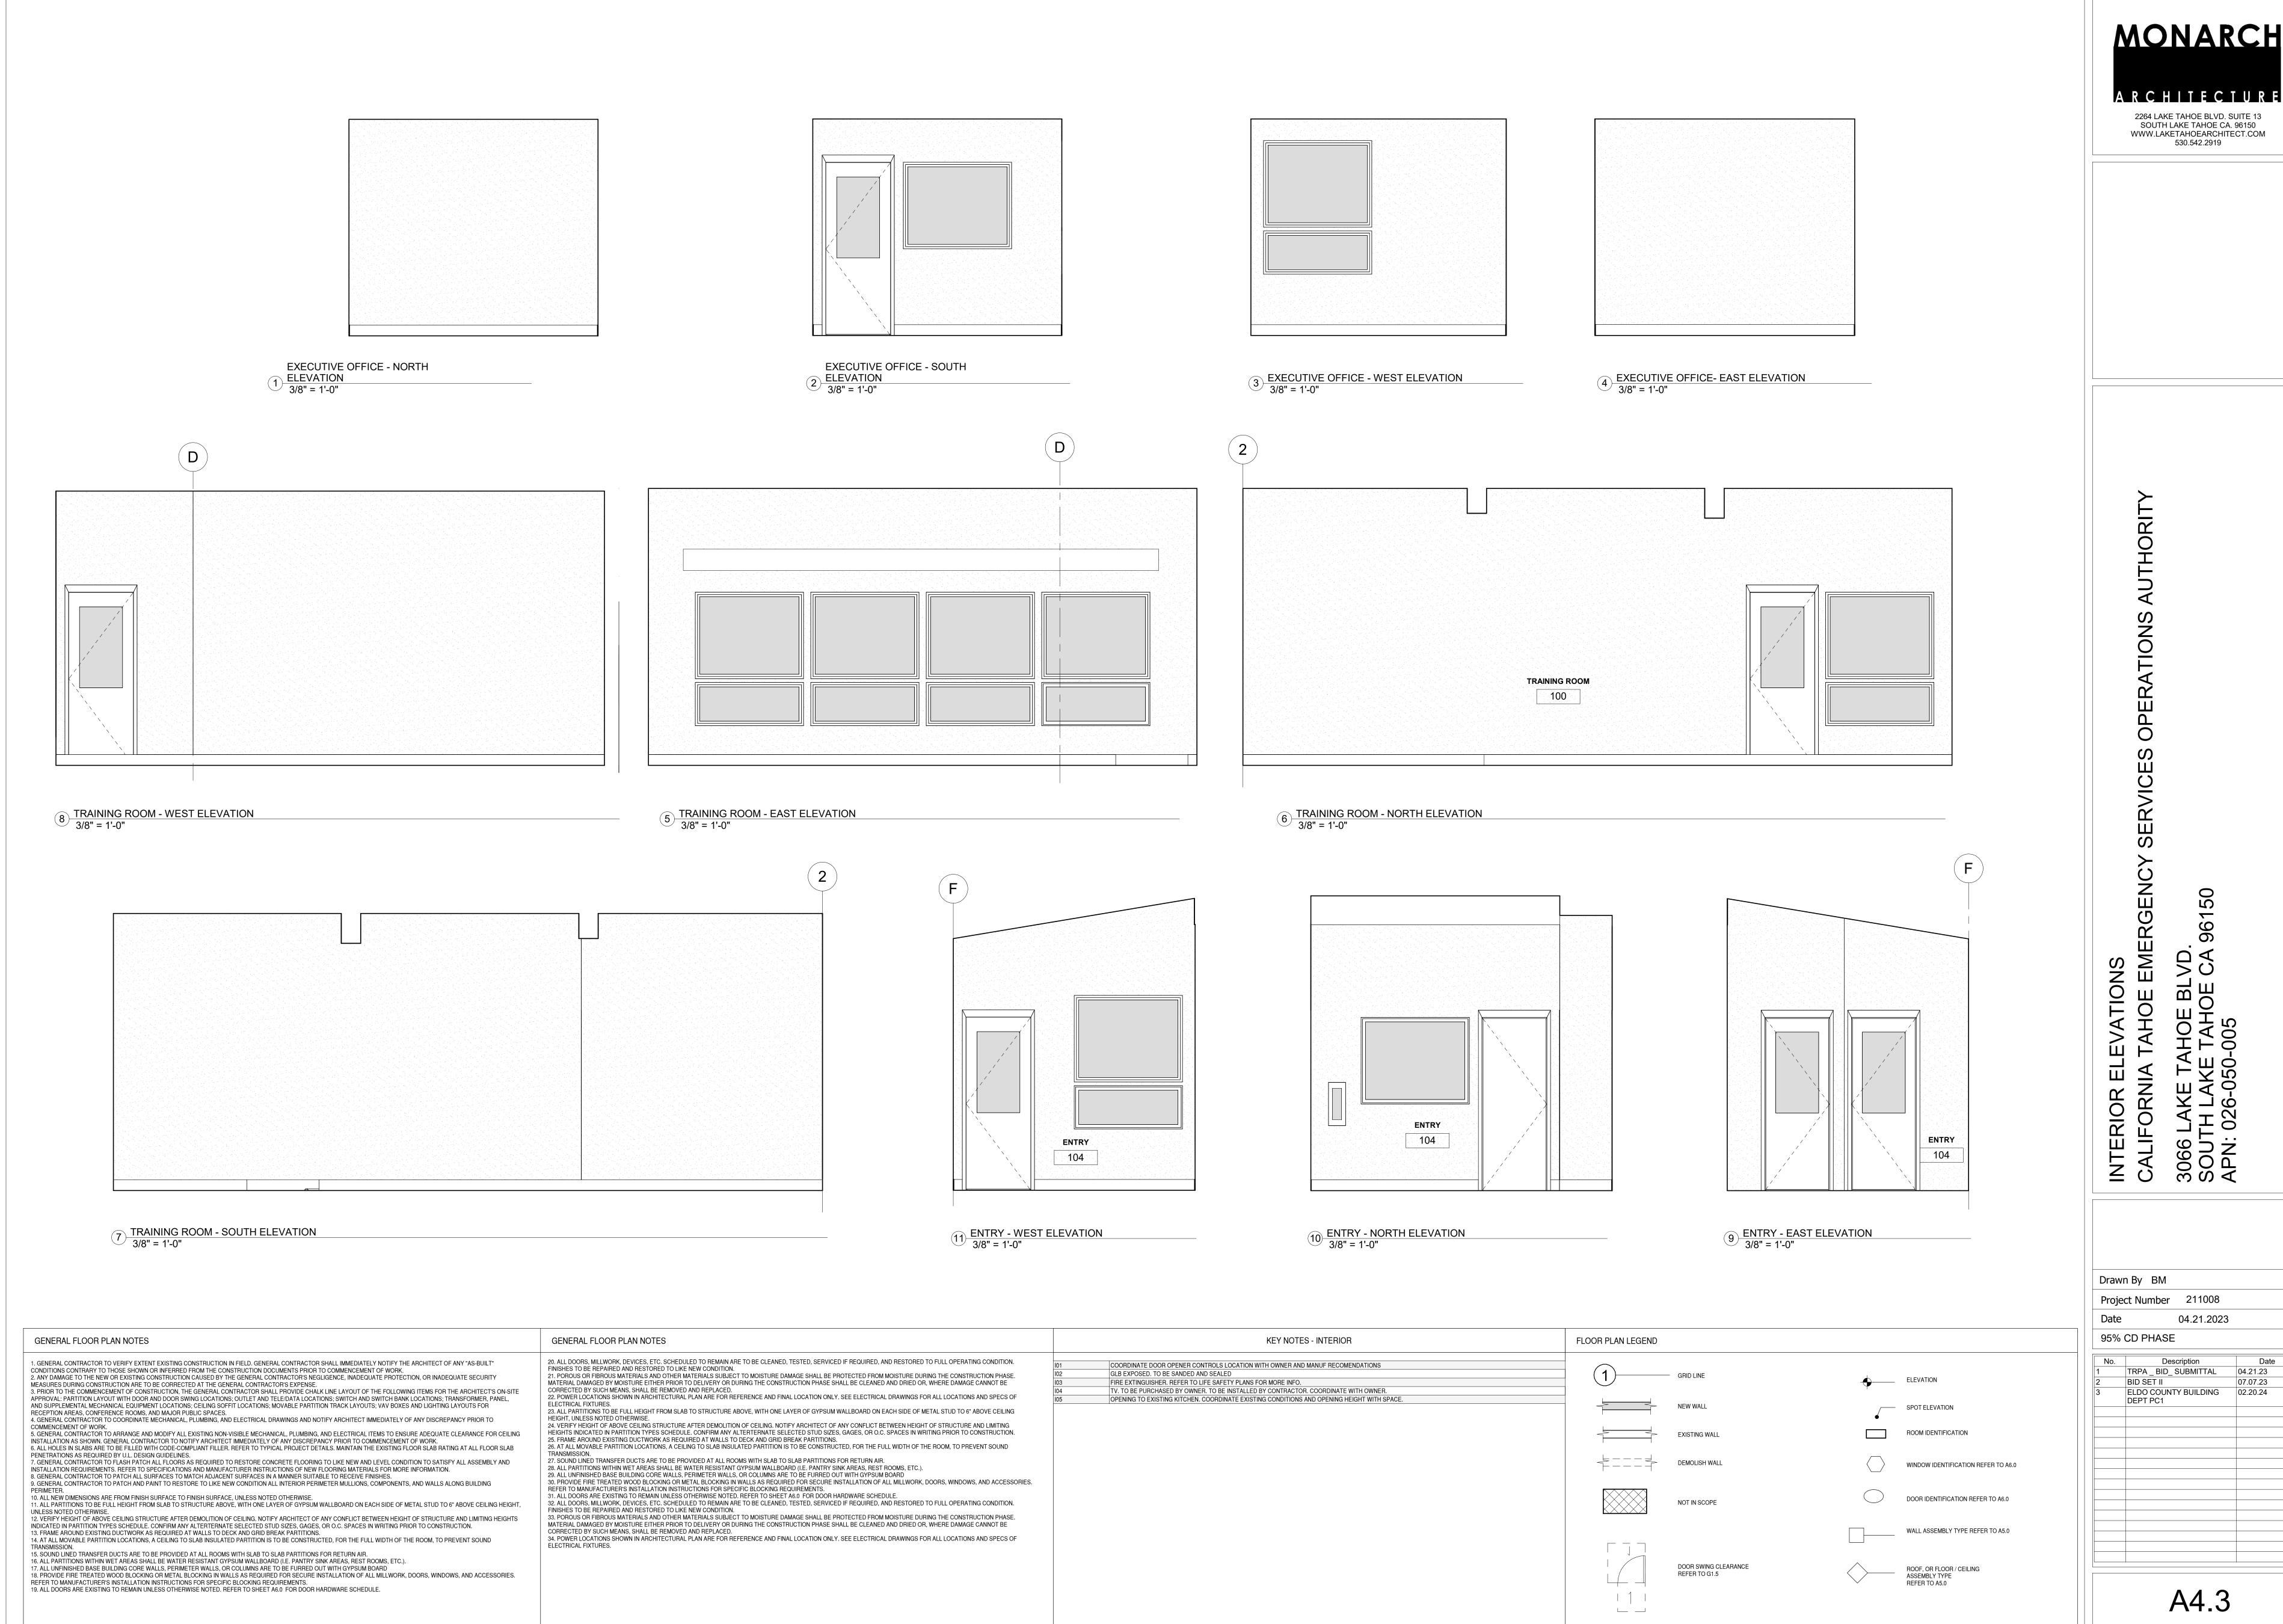

MONARCH

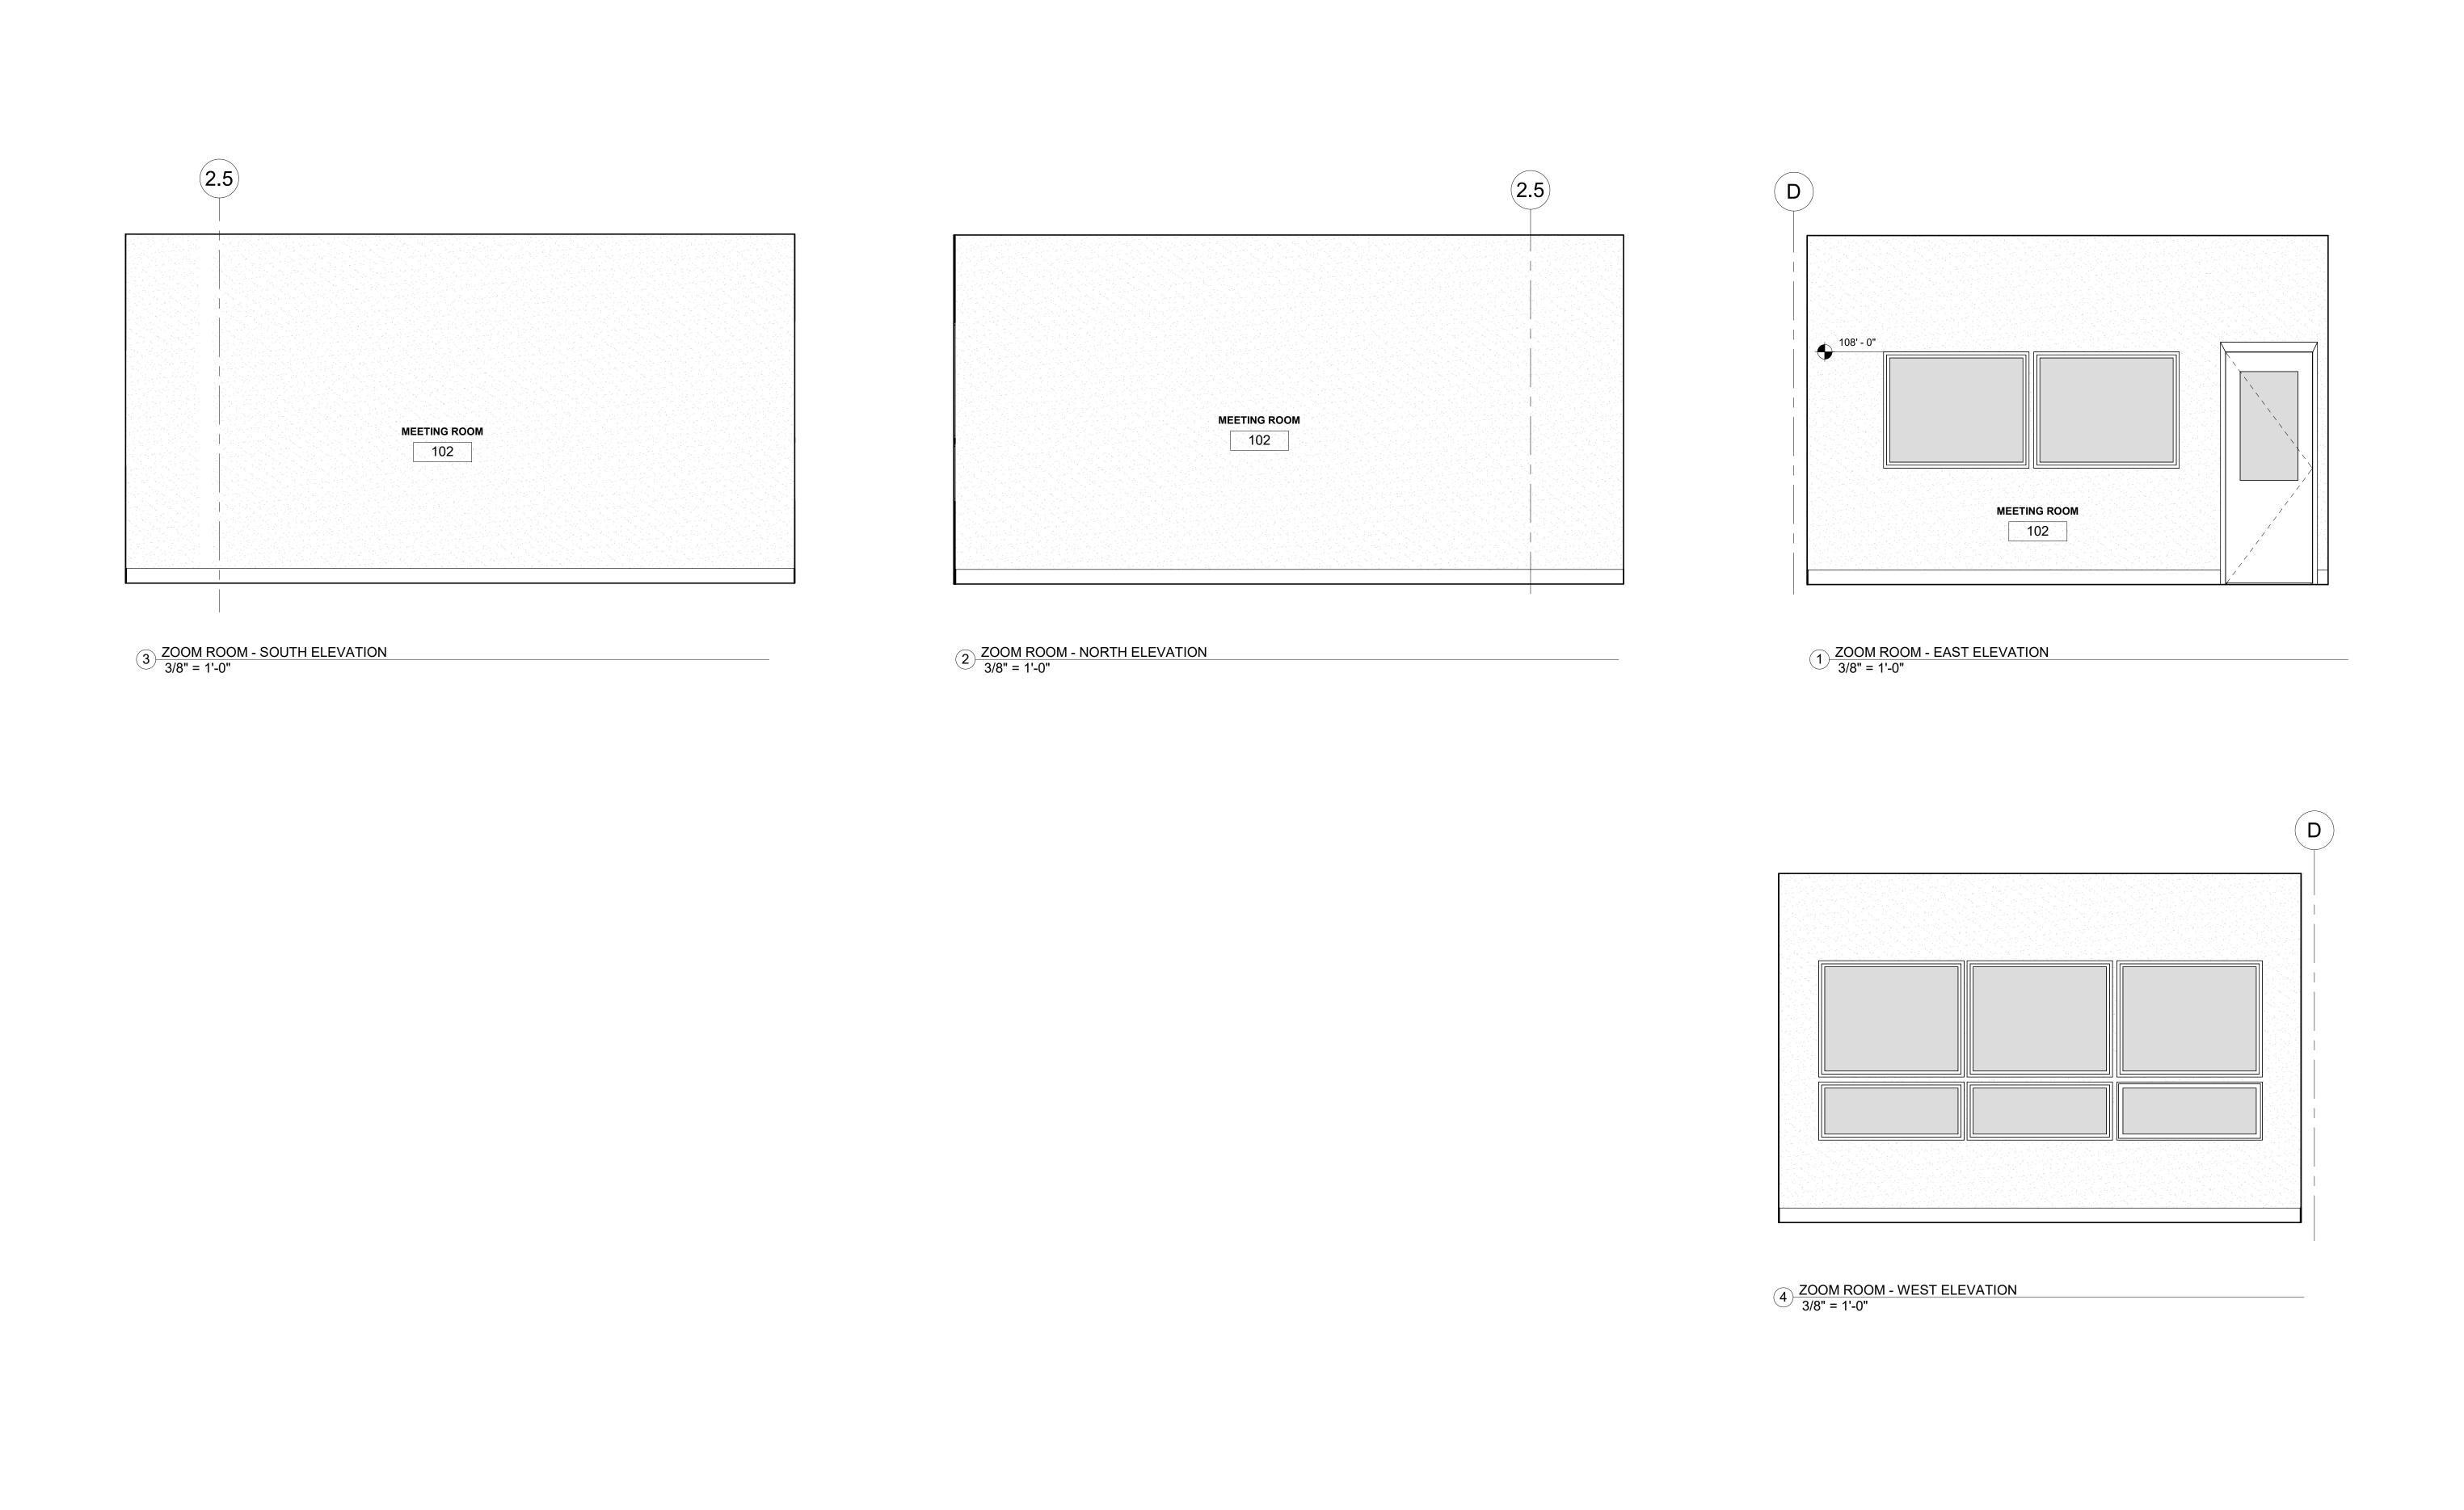

INTERIOR FINISH NOTES	FINISH SCHEDULE	INTERIOR FINISH SPECIFICATION	KEY NOTES - INTERIOR
ALL WALLS IN TOILET ROOMS ARE TO BE SHEATHED IN 5/8" WATER RESISTANT. TYPE "X" GYPSUM BOARD FROM FLOOR TO CEILING. ALL WALL SURFACES FACING KITCHEN & STORAGE AREAS ARE TO BE SHEATHED IN 5/8" WATER RESISTANT. TYPE "X" GYPSUM BOARD FROM FLOOR TO CEILING. PROVIDE IP BOAR AT ALL SURFACE FACING FOOD PREPERATION UNO, REFER TO ELEVATIONS. CONFIRM COLOR OF FRP WITH OWNER. ALL OTHER WALLS TO BE SHEATHED W/ 5/8" TYPE "X" GYP. BD. THROUGHOUT. PROVIDE BACKING FOR ATTACHMENTS AND FIXTURES AS NEEDED. WOOD FURRING TO BE LOCATED AS REQUIRED TO ATTACH DECORATIVE WOOD TRIM. ALL PAINTED WALL AND CEILING SURFACES ARE TO BE SMOOTH, NO TEXTURE. COLOR TO BE SBO IN KITCHEN, STORAGE AND FOOD PREP AREAS ANY PAINTED SURFACES TO BE SMOOTH HIGH GLOSS FINISH. ALL MATERIAL SELECTIONS AND SUBSTITUTIONS SHALL MEET THE REQUIREMENTS OF THE CALIFORNIA RETAIL FOOD CODE. ALL MATERIALS FOR KITCHEN AND RESTROOMS INCLUDING FLOORS, BASE (COVING), WALLS, CEILING INCLUDING COLOR AND SURFACE FINISHSH ALL BE APPROVED BY EL SPADO COUNTY ENVIRONMENTAL HEALTH PRIOR TO INSTALL. THIS INCLUDES ANY DEVIATIONS OR SUBSTITUTIONS FROM APPROVED BY OWNER/ ARCHITECT EQUIPMENT AND PLUMBING FIXTURES ARE TO BE USED AS A BASIS OF DESIGN. ALL CAN BE SUBSTITUTED ASSUMING "EQUAL" AND APPROVED BY OWNER/ ARCHITECT	Room Number Room Name Floor Finish Base Finish Wall Finish Ceiling Finish Comments	FLOORING F1 LUXURY VINYL PLANK FLOORING (LVP) - TO MATCH EXISTING BUILDING. BASIS OF DESIGN: DUSK CHERRY 6 MIL X 8.7 IN. W X 48 IN. L CLICK LOCK WATERPROOF LUXURY VINYL PLANK FLOORING - OR EQUAL F2 4" RUBBER BASE F3 3.8" THICK RUBBER FLOORING-ROLL. BASIS OF DESIGN: AMERICAN FLOOR MATS - RUBBER ROLLED FLOOR 3/8" THICK - OR EQUAL. COLOR TO BE SBO F4 EXPOSED CONCRETE - SEALED AMBULANCE GARAGE BAY WALL TREATMENT W1 TYPE-X GYPSUM BD. PAINTED: COLOR AND FINISH TO BE SELECTED BY OWNER U.N.O WATER RESISTANT GYP BD., RE: INTERIOR FINISH NOTES FOR LOCATIONS. W2 WALL TILE - GROUT TBD - TILE LOCATED IN SHOWER STALLS ONLY. W3 2x4" METAL STUD @ 16" O.C. WITH 5:8" TYPE-X GYP ON ONE SIDE. CEILING C1 EXPOSED LID. ALL CEILING FIXTURE TRIM, VENT COVER, OUTLET COVER ARE TO BE BLACK TO MATCH CEILING. COLOR: TO BE SBO C2 GYPSUM BOARD CEILING; PAINT COLOR: TO BE SBO.	ID1 COORDINATE DOOR OPENER CONTROLS LOCATION WITH OWNER AND MANUF RECOMENDATIONS (ID2 GLB EXPOSED. TO BE SANDED AND SEALED (ID3 FIRE EXTINGUISHER. REFER TO LIFE SAFETY PLANS FOR MORE INFO. (ID4 TV. TO BE PURCHASED BY OWNER. TO BE INSTALLED BY CONTRACTOR. COORDINATE WITH OWNER. (ID5 OPENING TO EXISTING KITCHEN. COORDINATE EXISTING CONDITIONS AND OPENING HEIGHT WITH SPACE.





INTERIOR ELEVATIONS
CALIFORNIA TAHOE EMERGENCY SERVICES OPERATIONS AUTHORITY
3066 LAKE TAHOE BLVD.


Proje	ct Number	211008			
Date		04.21.2023			
95% CD PHASE					
No.	Desc	cription	Date		
1	TRPA _ BID_ SUBMITTAL		04.21.23		
2	BID SET II		07.07.23		
3	ELDO COUNT DEPT PC1	Y BUILDING	02.20.24		


Drawn By BM

A4.4

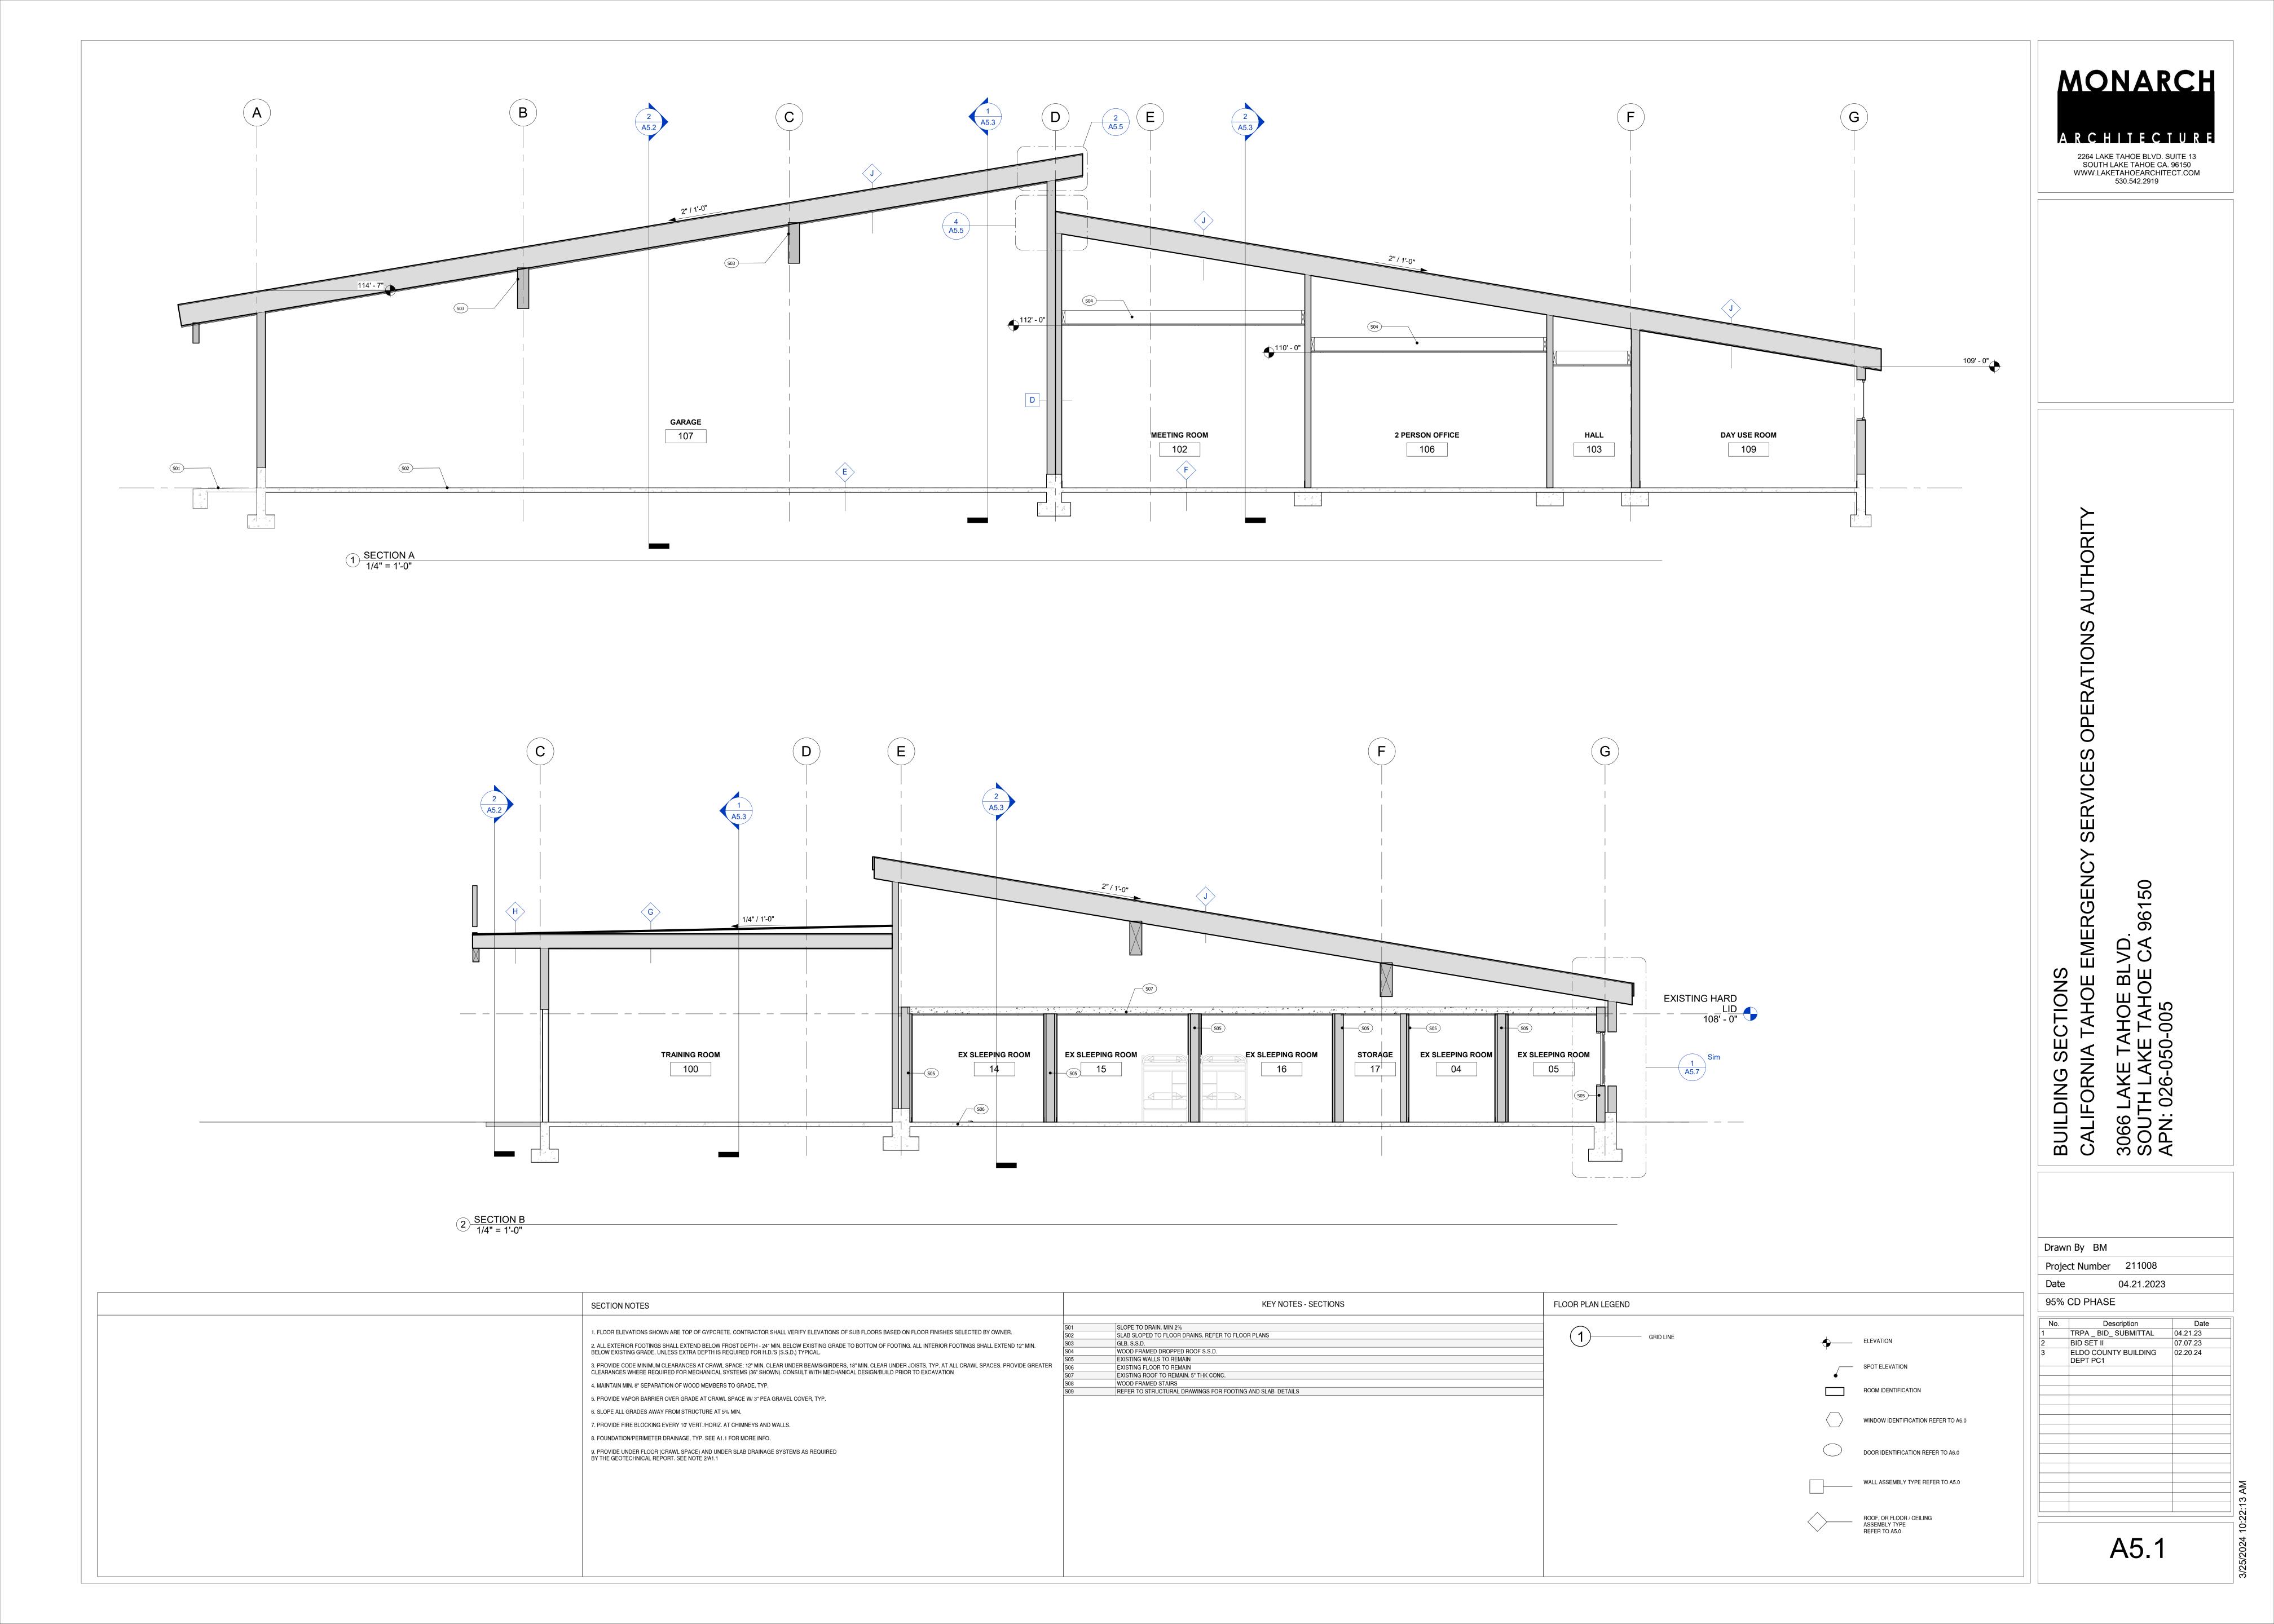


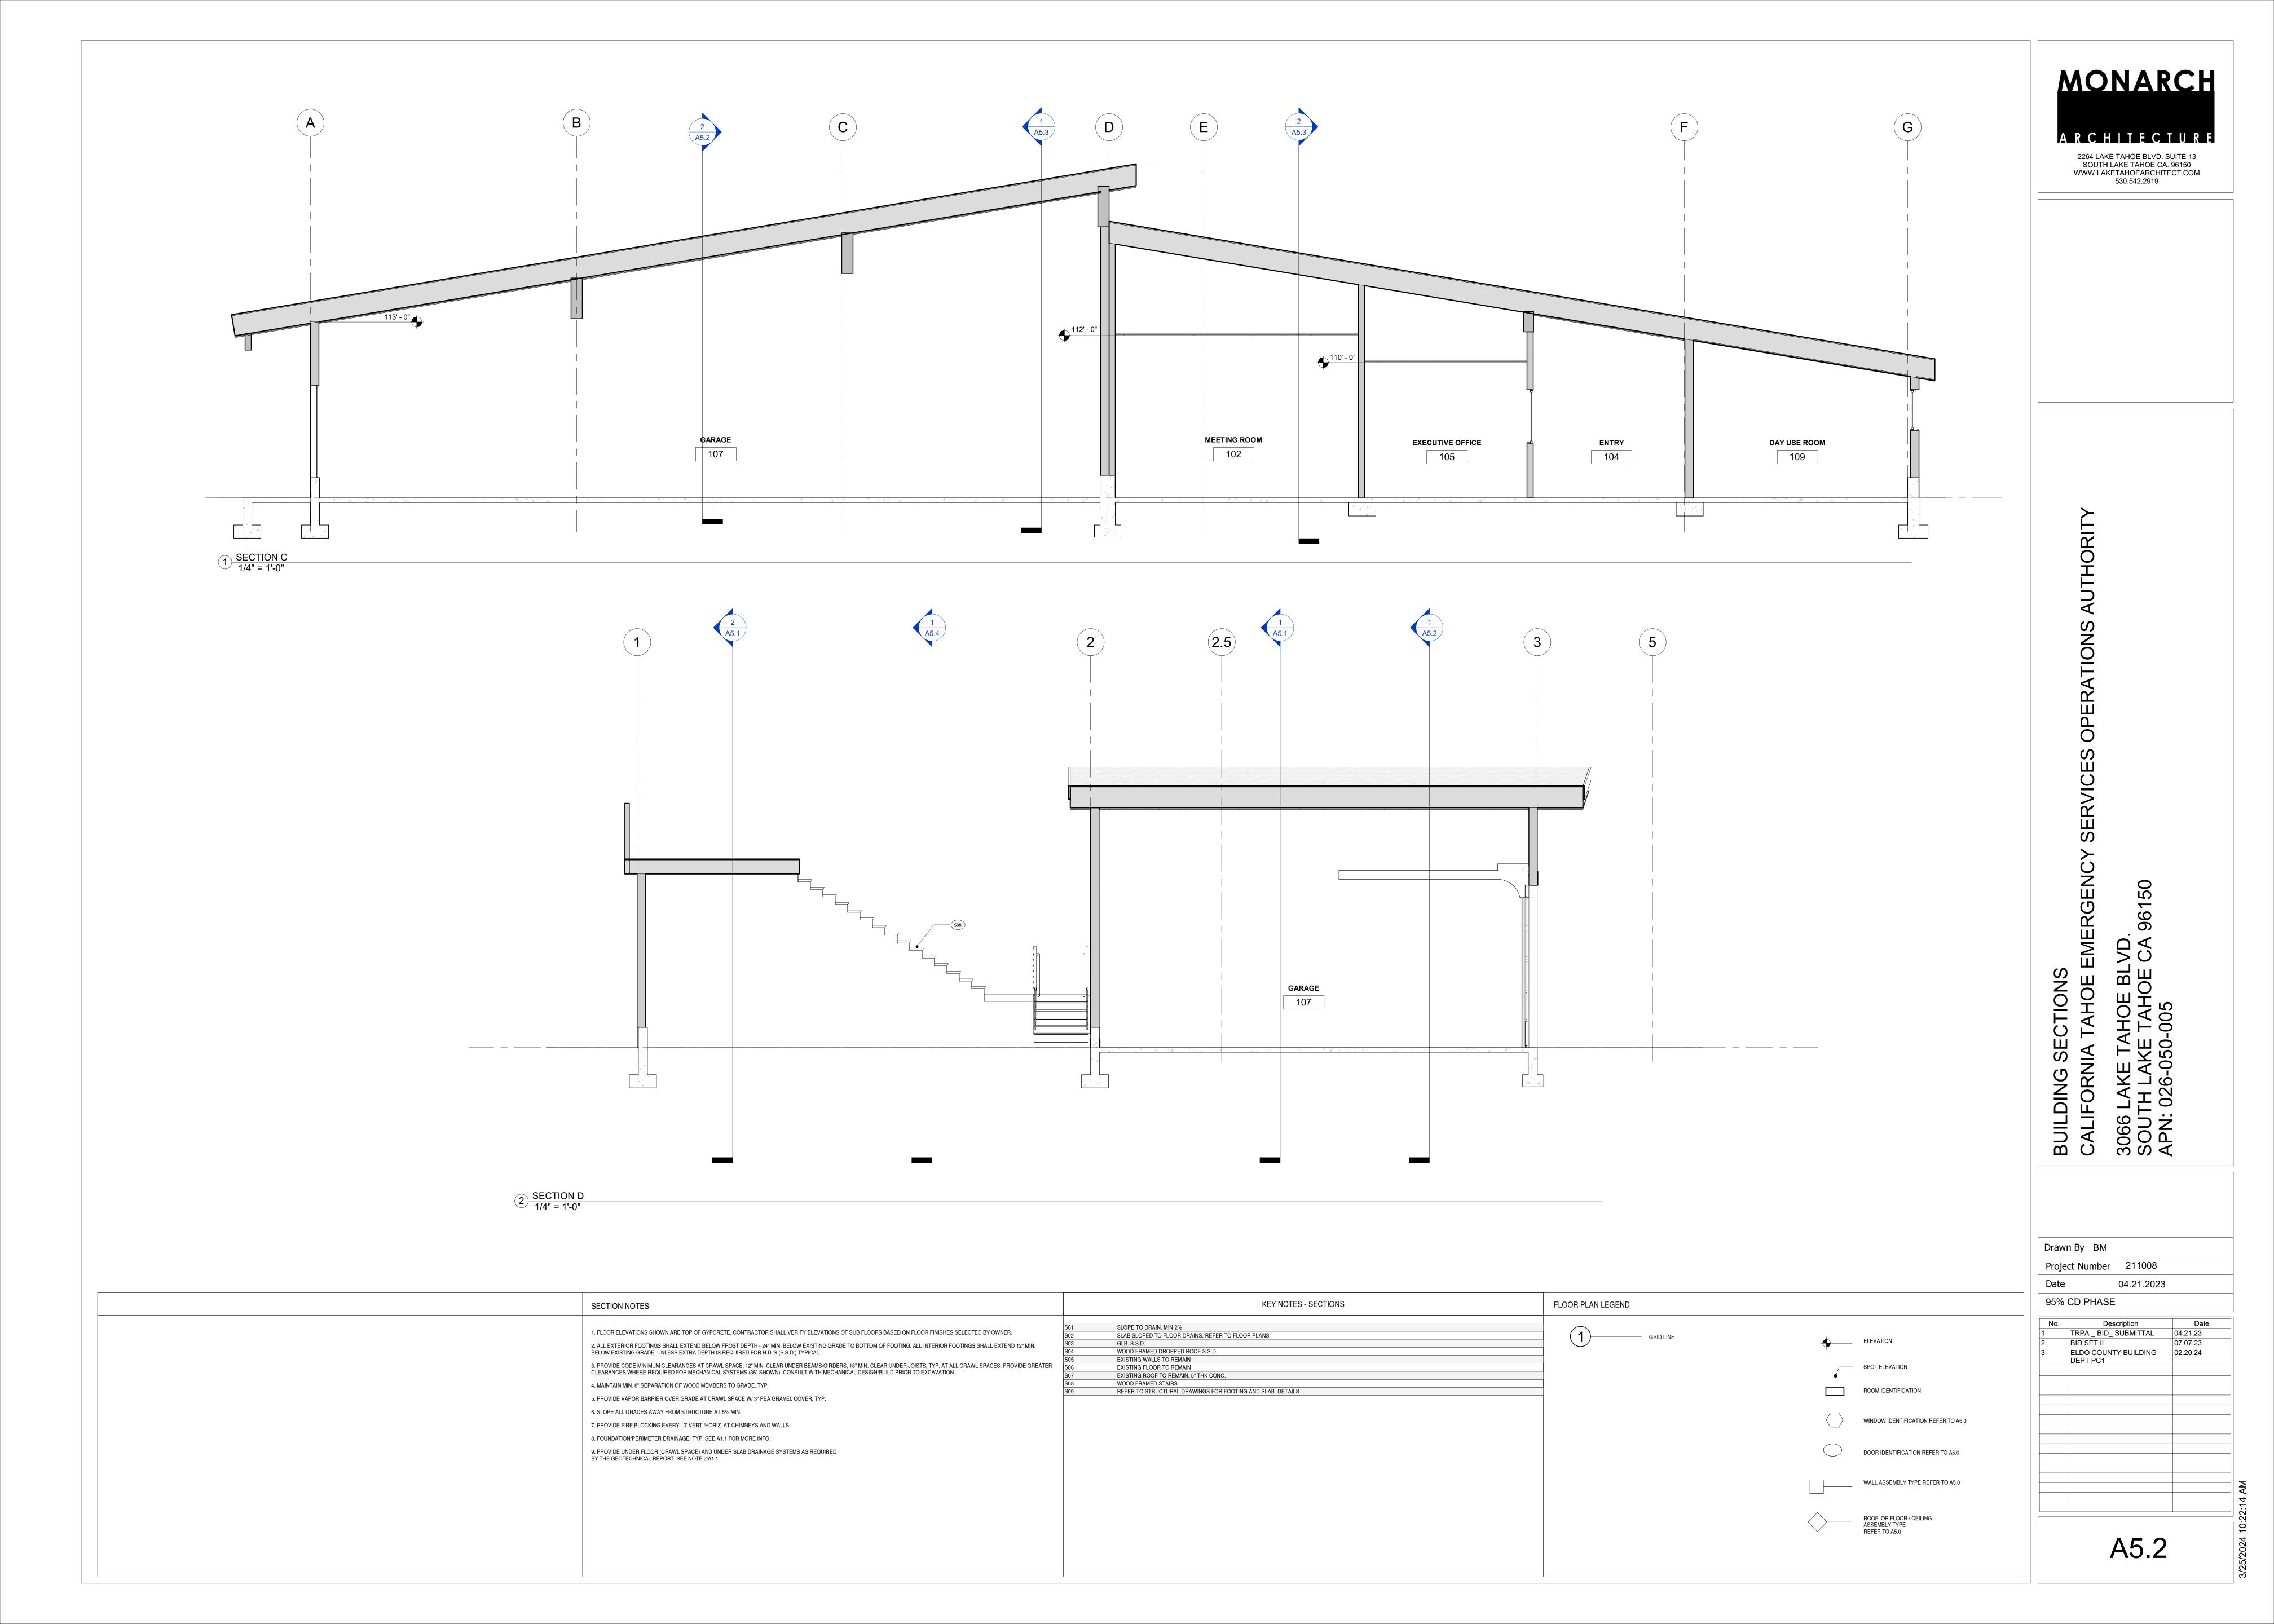

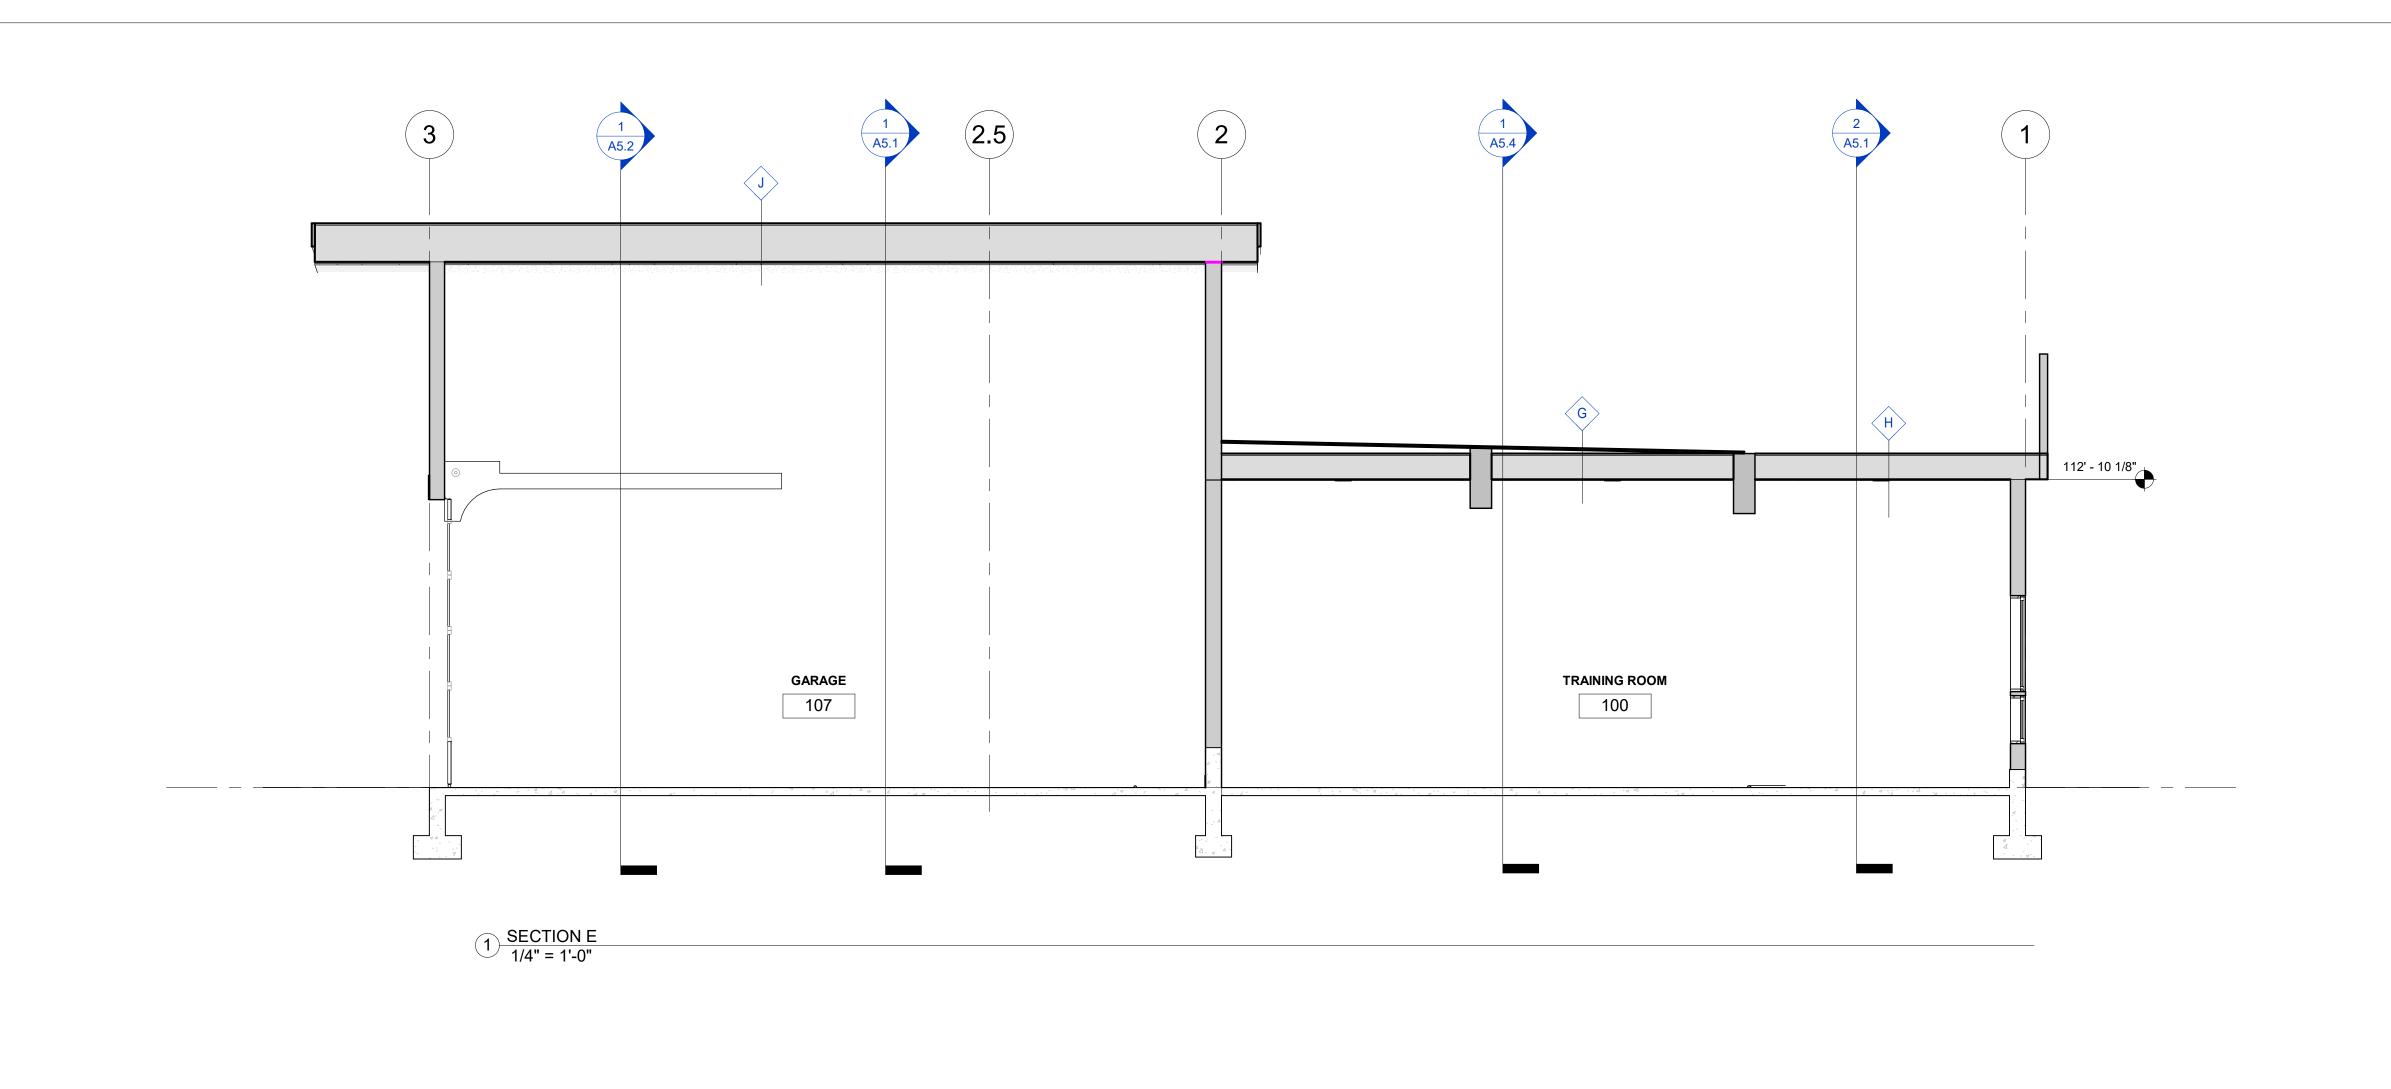

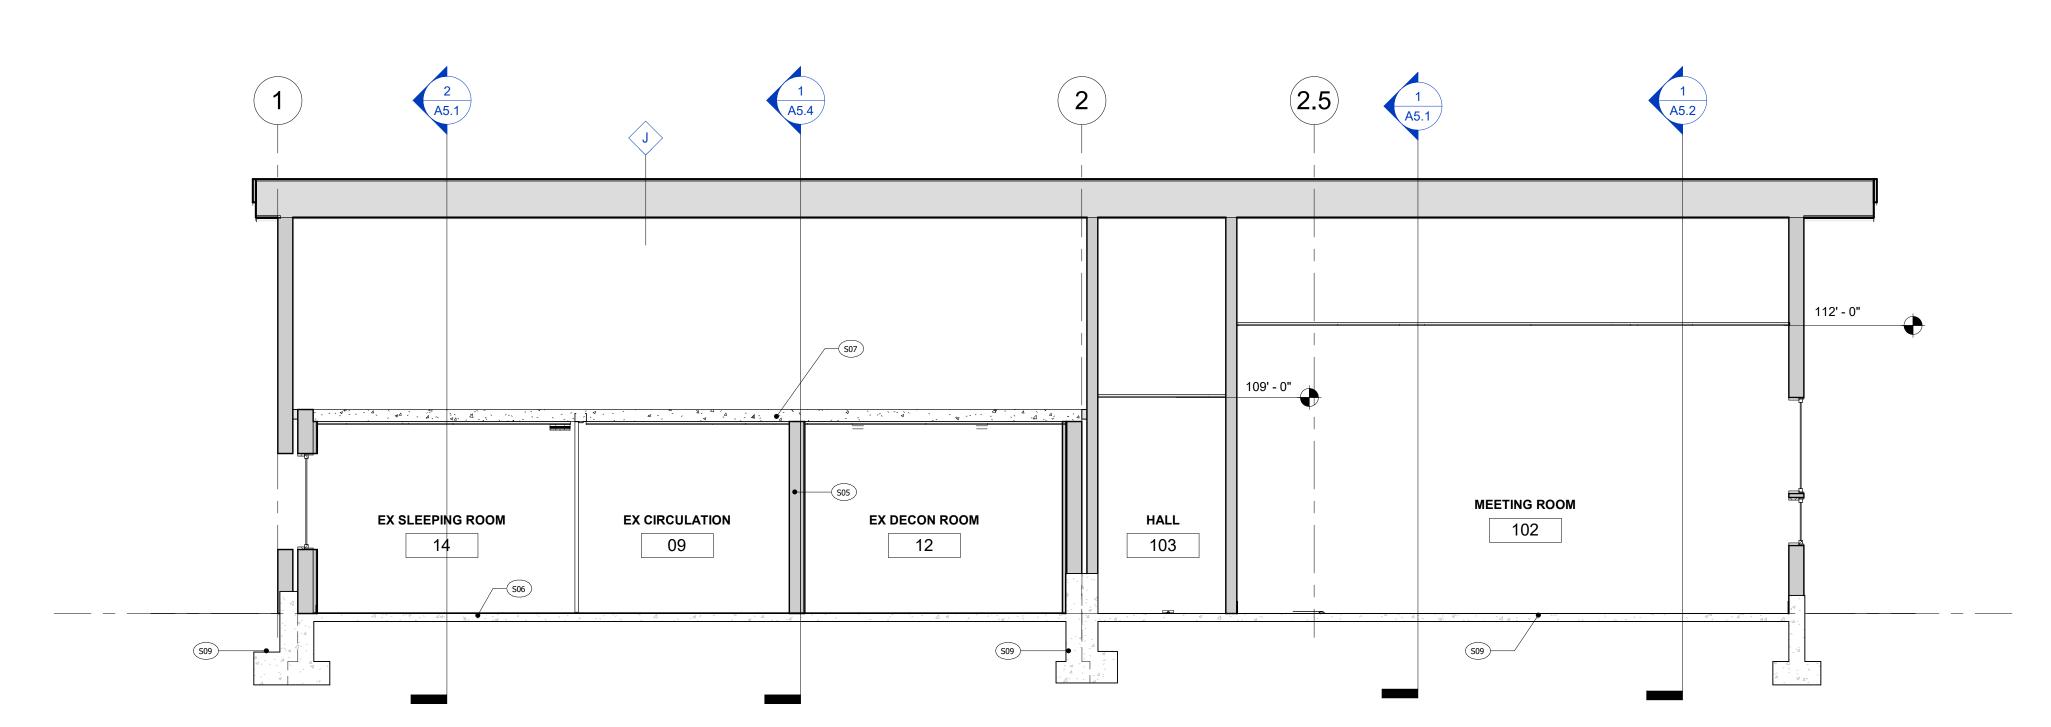

2 SECTION F 1/4" = 1'-0"

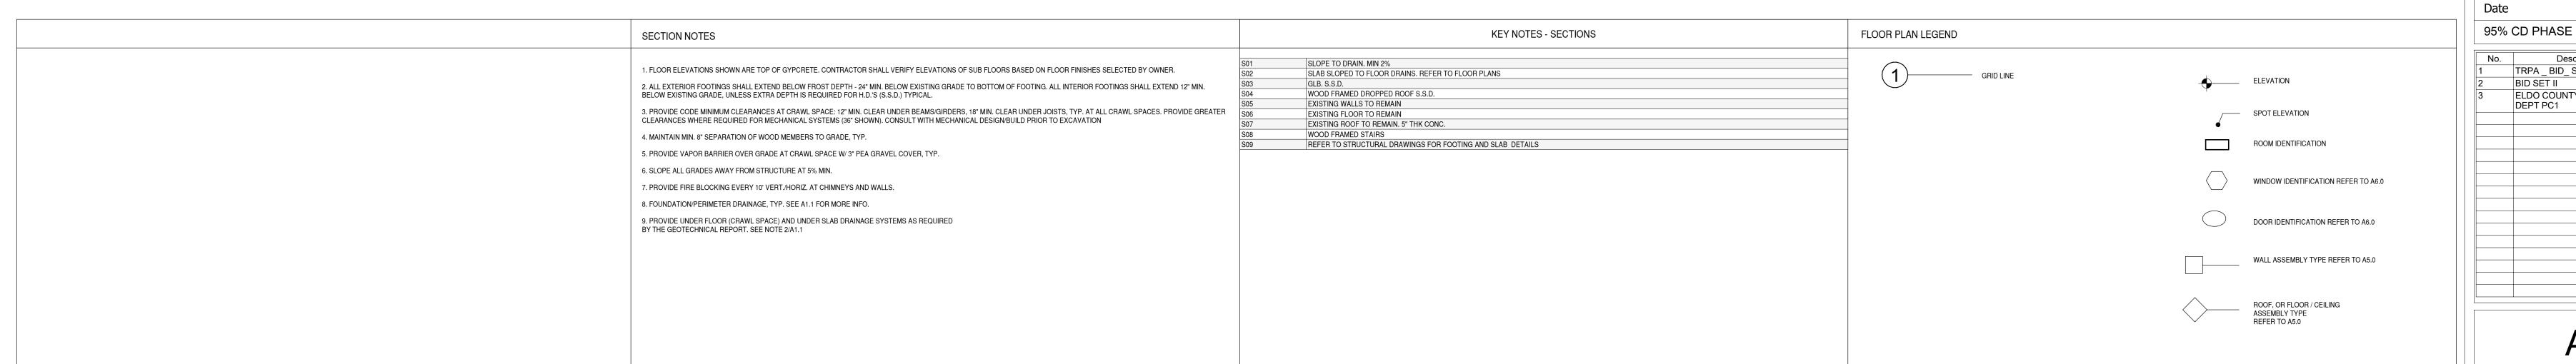



BUILDING SECTIONS

CALIFORNIA TAHOE EMERGENCY SERVICES OPERATIONS AUTHC

3066 LAKE TAHOE BLVD.

SOUTH LAKE TAHOE CA 96150

No. Description Date


1 TRPA_BID_SUBMITTAL 04.21.23
2 BID SET II 07.07.23
3 ELDO COUNTY BUILDING DEPT PC1

04.21.2023

Drawn By BM

Project Number 211008

A5.3

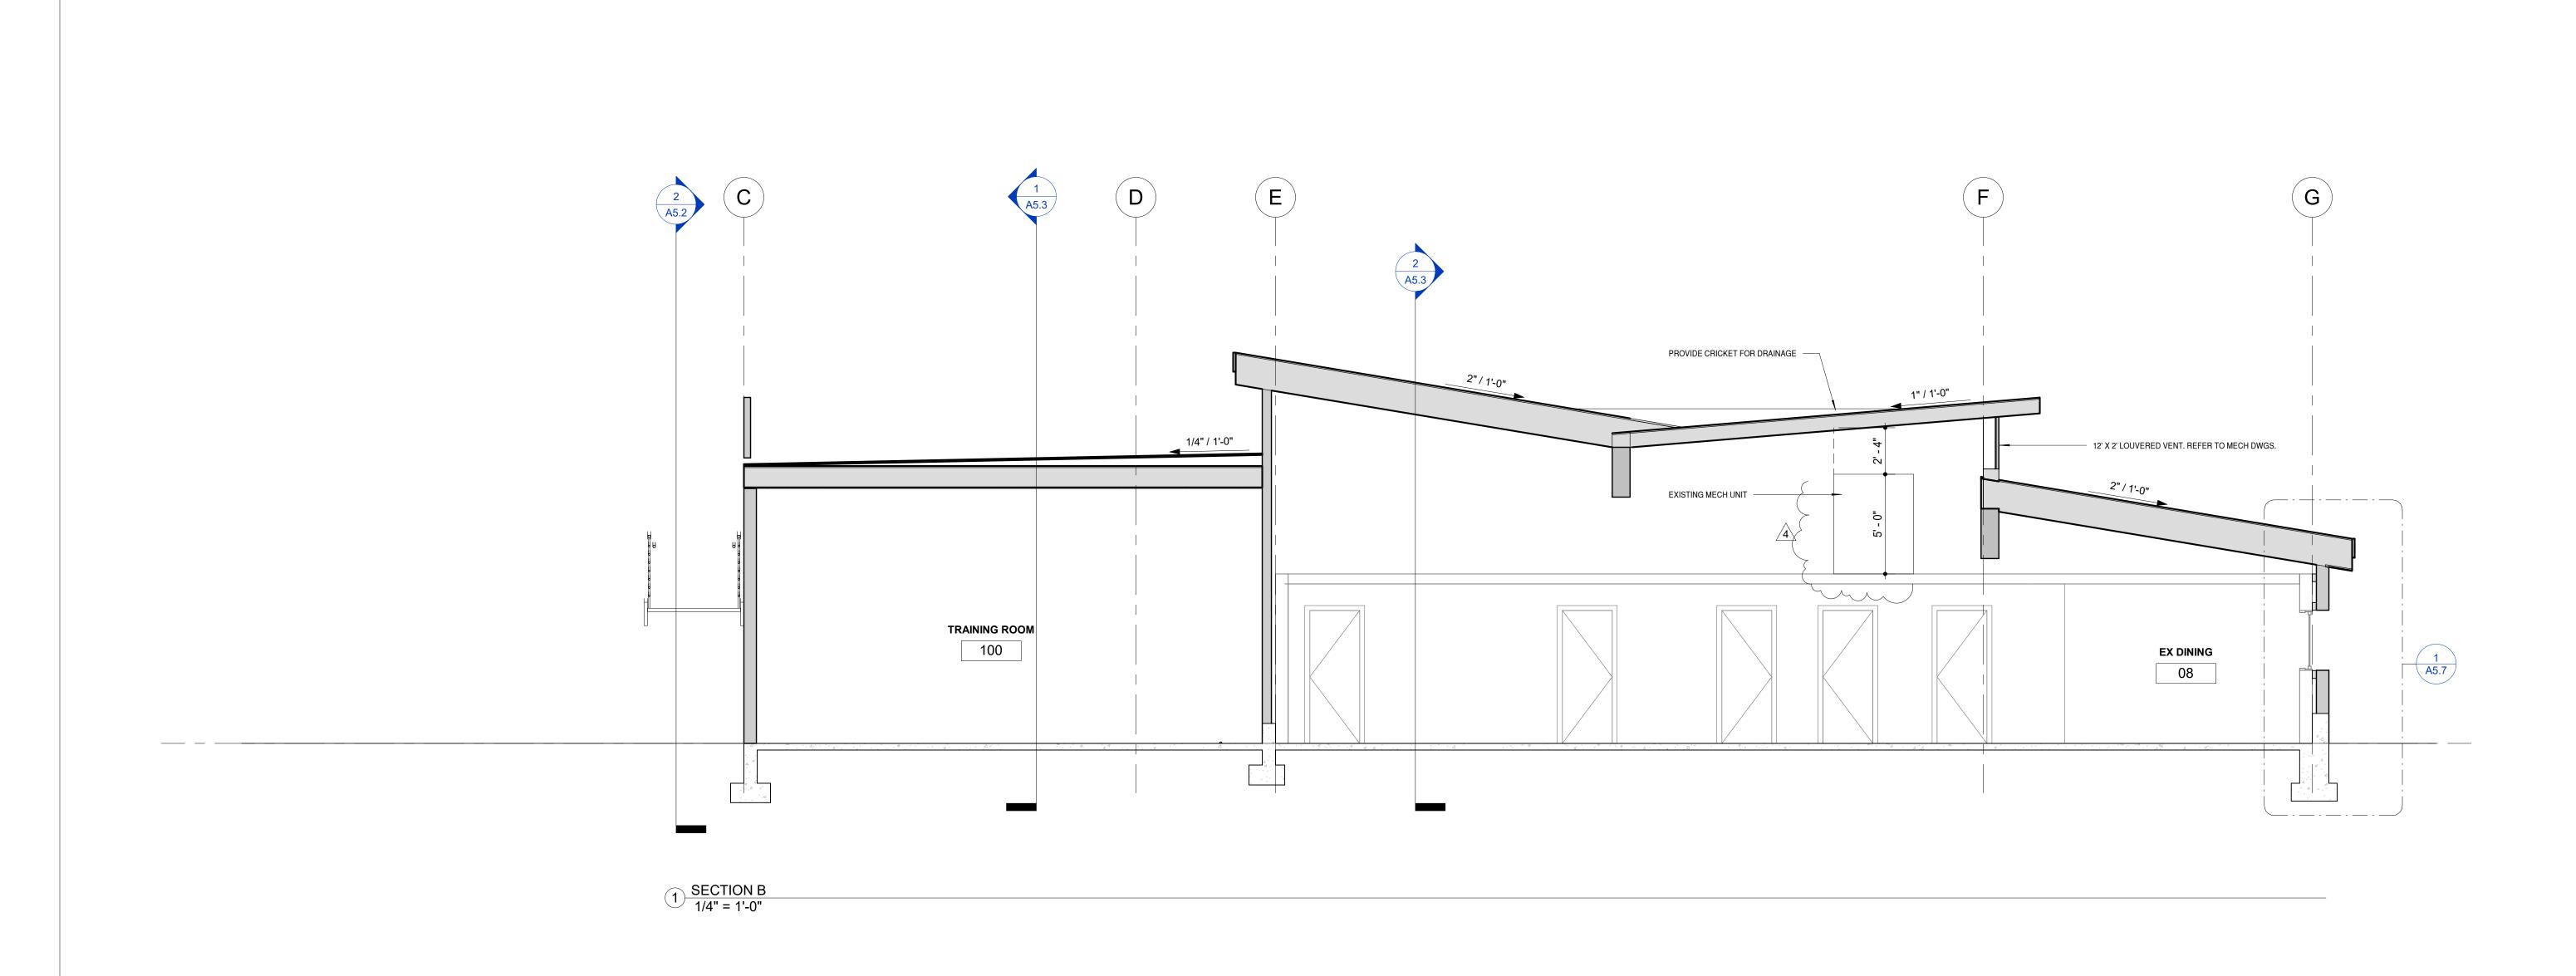



BUILDING SECTIONS

CALIFORNIA TAHOE EMERGENCY SERVICES OPERATIONS AUTHO

3066 LAKE TAHOE BLVD.

SOUTH LAKE TAHOE CA 96150

APN: 026-050-005

No. Description Date

3 ELDO COUNTY BUILDING 02.20.24

4 GC RFI Responses 03.20.24

Project Number 211008

95% CD PHASE

04.21.2023

A5.4